

#### **ACTIVITY DETERMINATION**

Project No. BGWW7

Conflict of Interest <sup>1</sup>	
In this matter:	
<ol> <li>I have declared any possible conflict of interests (real, Chief Executive, Land &amp; Housing Corporation.</li> <li>I do not consider I have any personal interests that wou</li> <li>I will inform the Acting Chief Executive, Land &amp; Housin aware of a possible conflict of interest.</li> </ol>	ıld affect my professional judgement.
Signed	
NameEmma Nicholson	Dated10 October 2023

Having regard to the Determination Recommendation Report, the Statement of Compliance and the Review of Environmental Factors for this project addressing matters under Part 5 of the *Environmental Planning and Assessment Act 1979*, I determine that the activity proceed as described below and subject to the identified requirements set out in **Schedule 1**.

SITE IDENTIFICATION						
STREET ADDRESS						
Unit/Street No	Street or property name					
189	Riverside Drive					
Suburb, town or locality		Postcode				
Airds		2560				
Local Government Area(s)	Real property description (Lot and D	P)				
Campbelltown	Lot 2004 in DP1292964					
ACTIVITY DESCRIPTION						
Provide a description of the activity						
Demolition (fence and concrete footpath), removal of trees and construction of a 2-storey boarding house comprising 8 self-contained rooms, a common room, parking for 2 vehicles (including 1 accessible space), 2 motorbikes and 4 bicycles, landscaping and fencing						

Conflict of interest includes actual and potential. A conflict of interest includes pecuniary i.e. financial interests to you or a related party or non-pecuniary i.e. benefits to relatives, friends, business associates and personal causes, etc. This includes "related persons" as defined in the Property, Stock and Business Agency Act 2002.

Dated 10 October 2023

Emma Nicholson
A/Head of Policy and Innovation
Land and Housing Corporation
Department of Planning & Environment

#### SCHEDULE 1

#### **IDENTIFIED REQUIREMENTS**

#### PART A - Standard Identified Requirements

#### THE DEVELOPMENT

The following Identified Requirements are to ensure that the residential activity is carried out in accordance with the plans / documents and any amendments arising from the Review of Environmental Factors under Part 5 of the Environmental Planning & Assessment Act 1979, Section 171 of the Environmental Planning and Assessment Regulation 2021 and the requirements of State Environmental Planning Policy (Housing) 2021.

1. The development shall be carried out substantially in accordance with the following plans / documents as modified below and by any of the undermentioned Identified Requirements:

Title / Name:	Drawing No / Document Ref	Revision / Issue:	Date [dd.mm.yyyy]:	Prepared by:
Architectural Plans				
Coversheet	20035 - A001	15	09.03.2023	Crawford Architects
Site Analysis Plan	20035 - A002	10	09.03.2023	Crawford Architects
Demolition/Tree Removal Plan	20035 - A003	07	09.03.2023	Crawford Architects
Deep Soil Area and Cos Analysis	20035 - A015	09	09.03.2023	Crawford Architects
Existing Site Survey	20035 - A100	08	09.03.2023	Crawford Architects
Site Plan	20035 - A101	08	09.03.2023	Crawford Architects
General Arrangement Plan – Ground Level	20035 - A200	16	09.03.2023	Crawford Architects
General Arrangement Plan – First Level	20035 - A201	13	09.03.2023	Crawford Architects
General Arrangement Plan - Roof	20035 - A202	10	09.03.2023	Crawford Architects
Cut & Fill Plan	20035 - A203	07	09.03.2023	Crawford Architects
Existing and Proposed Street View	20035 - A300	09	09.03.2023	Crawford Architects
Building Elevation	20035 - A301	12	09.03.2023	Crawford Architects
Building Section	20035 - A310	08	09.03.2023	Crawford Architects
3D Views and Finishes Schedule	20035 - A500	10	09.03.2023	Crawford Architects
Room Type Schedule	20035 - A501	06	09.03.2023	Crawford Architects

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Title / Name:	Drawing No /	Revision	Doto	Prepared by:
Title / Name:	Document Ref	/ Issue:	Date [dd.mm.yyyy]:	Prepared by:
Solar Diagrams – Ground Floor	20035 - A510	10	09.03.2023	Crawford Architects
Solar Diagrams – First Floor	20035 - A511	10	09.03.2023	Crawford Architects
Shadow Diagrams	20035 - A520	09	09.03.2023	Crawford Architects
Civil/ Stormwater Plan				
Stormwater Site	C01	l F	22.03.2023	Michael Ell Consulting
Drainage Layout Plan				Engineers
Stormwater Details	C02	В	10.05.2022	Michael Ell Consulting Engineers
Soil and Erosion Control Plan	C03	D	11.01.2023	Michael Ell Consulting Engineers
Erosion and Sediment Control Details	C04	С	07.02.2022	Michael Ell Consulting Engineers
Hydraulic Plans				
Cover Sheet	H-000	5	22.11.2022	Marline Building Services Engineers
Legend, Notes & Schedule	H-001	5	22.11.2022	Marline Building Services Engineers
Site Services	H-100	5	22.11.2022	Marline Building Services Engineers
Landscape Plans				
Cover Sheet	000	I	03.04.2023	Site Image Landscape Architects
Landscape Plan	101	J	03.04.2023	Site Image Landscape Architects
Landscape Details	501	В	07.07.2022	Site Image Landscape Architects
Landscape Details	502	А	14.07.2022	Site Image Landscape Architects
Notification Plans				
Notification Cover	A700	11	09.03.2023	Crawford Architects
Notification Plan	A701	09	09.03.2023	Crawford Architects
Development Data	A702	11	09.03.2023	Crawford Architects
Notification Elevations	A703	10	09.03.2023	Crawford Architects
Notification Finishes Schedule	A704	11	09.03.2023	Crawford Architects
Shadow Diagrams	A705	08	09.03.2023	Crawford Architects
BASIX and NatHERS	104017014 00	1	00.14 1.0000	The P hi di
BASIX Certificate	1342172M_02	-	29 March 2023	Marline Newcastle  Marline Newcastle
NatHERS Certificate	0008089781 0008089799 0008089807 0008089815 0008089823 0008089831 0008089849 0008089856	-	26 September 2022	Martine Newcastle
Reports				_
Access Report	LP_20279	Rev. 4	22 March 2023	Lindsay Perry Access
Arboricultural Assessment and Tree Protection Plan	189 Riverside Drive, Airds	1.2	12 September 2022	Vertical Tree Management & Consultancy
BCA Design Compliance Assessment	P220060	4	21 March 2023	BCA Vision
Geotechnical Investigations	20/1924	-	19 June 2020	STS Geotechnics
Waste Management Plan	E963	В	25 November 2022	Creative Planning Solutions
Traffic Assessment	426	-	18 November 2022	Amber Organisation
Bushfire Protection	20PIE07		20 December	Travers Bushfire & Ecology

# Activity Determination 189 Riverside Drive, Airds

Title / Name:	Drawing No / Document Ref	Revision / Issue:		Prepared by:
Assessment			2022	

- 2. All building work is to be undertaken in accordance with the National Construction Code and referenced Australian Standards.
- **3.** All commitments listed in the BASIX certificate and stamped plans shall be implemented.
- **4.** All construction documentation and building work is to be certified in accordance with Section 6.28 of the *Environmental Planning and Assessment Act 1979*.

#### **OPERATIONAL MATTERS**

The following Identified Requirements relate to the use of the site and are to ensure that the activity and its operation do not interfere with the amenity of the surrounding area.

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#### Stormwater Run-off

- 5. Stormwater shall be collected within the site and conveyed in a pipeline to the appropriate gutter or drain under the control of Campbelltown City Council substantially in accordance with the approved concept stormwater drainage plans.
- 6. Alterations to the natural surface contours or surface absorption characteristics of the site shall not impede, increase or divert natural surface water runoff so as to cause a nuisance to adjoining property owners.
- 7. All driveways shall be graded in such a manner as to provide continuous surface drainage flow paths to the appropriate points of discharge.
- **8.** To prevent water from entering buildings, surface waters shall be collected and diverted clear of the buildings by a sub-surface / surface drainage system.

#### Vehicular Access & Parking

- 9. A concrete vehicular crossing and layback shall be provided at the entrance/exit to the property. The crossing and layback shall be constructed in accordance with Campbelltown City Council's standard requirements for residential crossings. Council shall be provided with plans for the crossing and layback together with the payment of any council inspection fees.
- 10. Particular care shall be taken in the location of vehicular crossings and/or laybacks to avoid poles, pits etc. The cost of any necessary adjustments to utility mains and services associated with the construction of the layback/driveway shall be borne by the Land & Housing Corporation. Obsolete gutter layback(s) shall be constructed as kerb in accordance with Campbelltown City Council's standards.

#### Note:

It is recommended that discussion be held with the relevant authorities before construction works commence.

11. Car parking spaces and driveways shall be constructed of concrete or other approved hard surfaced materials. The spaces must be clear of obstructions and columns, permanently line marked and provided with adequate manoeuvring facilities. The design of these spaces must comply with AS 2890.1.

#### Site Works

- 12. All soil erosion and sediment control measures required to be put in place prior to the commencement of demolition / construction works shall be maintained during the entire period of the works until all the disturbed areas are restored by turfing, paving or revegetation. Soil erosion and sediment control measures shall be designed in accordance with the guidelines set-out in the Blue Book *Managing Urban Stormwater:* Soils and Construction (4th edition, Landcom, 2004).
- 13. An appropriately qualified person shall design retaining walls or other methods necessary to prevent the movement of excavated or filled ground, including associated stormwater drainage measures.

#### **Building Siting**

14. All buildings shall be sited well clear of any easements affecting the site. The builder shall ascertain if any easements do exist and, if they do, obtain full details of such prior to construction commencing.

#### Smoke Detection System(s)

- 15. Smoke detection systems shall be installed throughout the building in accordance with requirements of Clause E2.2a of the Building Code of Australia. Detectors and alarms shall comply with AS 3786 and AS 1670 and must:
  - i. be connected to a permanent 240V power supply; and
  - ii. be provided with a battery backup to activate the alarm unit in the event of failure of the permanent power supply.

#### Site Soil Contamination

16. If the site is identified as being potentially affected by soil contamination, it shall be inspected by a suitably qualified person to identify any contaminated or hazardous material present. A proposal for remediation shall be prepared, which may include preparation of a Remedial Action Plan, and remediation shall be carried out in accordance with the proposal. A Validation Report, prepared in accordance with Environment Protection Authority requirements, shall be obtained from a qualified expert on completion of the remediation work to verify that the site is suitable for the intended residential use. A copy of the Validation Report shall be provided to the Land & Housing Corporation on completion of the remediation works.

#### Landscaping

- 17. Landscaping shall be carried out substantially in accordance with the approved landscape plan(s) and maintained for a period of 12 months by the building contractor. Campbelltown City Council shall be consulted in relation to the planting of any street trees.
- 18. All scheduled plant stock shall be pre-ordered, prior to commencement of construction or 3 months prior to the commencement of landscape construction works, whichever occurs sooner, for the supply to the site on time for installation. The builder shall provide written confirmation of the order to the Land & Housing Corporation.

#### Tree Removal

19. Removal of trees within the boundaries of the site is to be carried out in accordance with the trees shown for removal on the approved demolition/tree removal plan (drawing A0003) and Arboricultural Assessment and Tree Protection Plan and no other trees shall be removed without further approval(s).

#### Fencing

**20.** All front fencing and gates shall be constructed wholly within the boundaries of the site. Any gates associated with the fencing shall swing inwards towards the site.

#### **Provision of Letterbox Facilities**

21. Suitable letterbox facilities are to be provided in accordance with Australia Post specifications.

#### **Public Liability Insurance**

**22.** A valid public liability insurance policy of at least \$10M shall be maintained throughout the demolition / construction works by the contractor.

#### PRIOR TO ANY WORK COMMENCING ON THE SITE

The following Identified Requirements are to be complied with prior to any work commencing on the site, including demolition.

#### Disconnection of Services

- 23. All services that are required to be disconnected shall be appropriately disconnected and made safe prior to commencement of the demolition / construction works. The various service authorities shall be consulted regarding their requirements for the disconnection of services.
- **24.** All existing services within the boundary to remain live shall be identified, pegged and made safe.

#### Demolition

- 25. The builder shall notify the occupants of premises on either side, opposite and at the rear of the site a minimum of five (5) working days prior to demolition. Such notification shall be clearly written on an A4 size paper giving the date demolition will commence and be placed in the letterbox of every premise (including every unit in a multi-unit residential building or mixed-use building). The demolition shall not commence prior to the date that is stated in the notice letter.
- 26. Prior to the demolition, a Work Plan shall be prepared by a competent person(s) in accordance with AS 2601 and shall be submitted to the Land & Housing Corporation. The Work Plan shall outline the identification of any hazardous materials (including surfaces coated with lead paint), method of demolition, the precautions to be employed to minimise any dust nuisance and the disposal methods for hazardous materials.
- 27. If buildings to be demolished are determined as, or suspected of, containing asbestos cement, a standard commercially manufactured sign containing the words 'DANGER ASBESTOS REMOVAL IN PROGRESS', and measuring not less than 400mm x 300mm, shall be erected in a prominent visible position on the site for the duration of the demolition works.

#### Note:

Any buildings constructed before 1987 is assumed to contain asbestos.

#### **Utilities Service Provider Notification**

28. The demolition / construction plans shall be submitted to the appropriate water utility's office (e.g. Sydney Water office) to determine whether or not the development will affect the utility's sewer and water mains, stormwater drains and any easements.

#### Note:

If the development complies with water utility's requirements, the plans will be stamped indicating that no further requirements are necessary.

#### Council Notification

29. Campbelltown City Council shall be advised in writing, of the date it is intended to commence work, including demolition. A minimum period of **five (5)** working days notification shall be given.

#### Site Safety

- **30.** A sign shall be erected in a prominent position on any site on which demolition or building work is being carried out:
  - (a) showing the name, address and telephone number of the responsible Land & Housing Corporation officer for the work, and
  - (b) showing the name of the principal contractor (if any) and a telephone number on which that person may be contacted outside working hours, and
  - (c) stating that unauthorised entry to the work site is prohibited.

The sign shall be maintained while the work is being carried out but shall be removed when the work has been completed.

#### Note:

This requirement does not apply in relation to building work that is carried out inside an existing building that does not affect the external walls of the building.

31. A minimum 1.8m high security fence or Class A / Class B (overhead) hoarding must be erected between the work site and any public place prior to demolition / construction. Access to the site shall be restricted to authorised persons only and the site shall be secured against unauthorised entry when demolition / construction work is not in progress or the site is otherwise unoccupied.

#### Note:

Approval from the relevant roads authority will be required under Section 138 of the Roads Act 1993 where a Class A or B hoarding encroaches onto the footpath of / or a public thoroughfare within a classified road.

**32.** No building or demolition materials are to be stored on the footpath or roadway.

#### Site Facilities

- **33.** The following facilities shall be installed on the site:
  - (a) Toilet facilities shall be provided at the rate of 1 toilet for every 20 persons or part thereof employed at the site. Each toilet provided shall be a standard flushing toilet and shall be connected to a public sewer or if connection to a public sewer is not practicable, to an accredited sewerage management facility provided by Campbelltown City Council or if this is not practicable to some other council approved management facility.
  - (b) Adequate refuse disposal methods and builders storage facilities. Builders' wastes, materials or sheds shall not to be placed on any property other than that which this approval relates to.

**34.** Access to the site shall only be provided via an all-weather driveway on the property and is not to be provided from any other site.

#### **Protection of Trees**

35. Trees and other vegetation that are to be retained on site shall be protected prior to the commencement of works and for the duration of the construction period in accordance with the details provided in the Arboricultural Assessment and Tree Protection Plan.

#### Waste Management

**36.** A final Waste Management Plan shall be prepared and submitted to the Land & Housing Corporation by the building contractor prior to the commencement of demolition / construction. The plan shall detail the amount of waste material and the destination of all materials, recyclable and non-recyclable.

#### PRIOR TO ANY CONSTRUCTION WORK COMMENCING ON SITE

The following Identified Requirements are to be complied with prior to any construction works occurring on the site, excluding demolition.

#### Service Authority Clearances

**37.** A compliance certificate, or other evidence, shall be obtained from Sydney Water, confirming service availability and impacts to existing assets prior to work commencing.

#### Note:

Payment of water and/or sewer service charges and/or a notice of requirements for works to be carried out during construction/prior to occupation may be applicable prior to issue of the compliance certificate.

- **38.** A written clearance from an electricity supply authority stating that electrical services are available to the site, or that arrangements have been entered into for the provision of services to the site, shall be obtained prior to work commencing.
- **39.** A certificate from an approved telecommunications carrier certifying that satisfactory arrangements have been made for the provision of underground telephone services, to the site and to each dwelling, shall be obtained prior to work commencing.
- **40.** Where the site is to be connected to reticulated gas, a certificate from an approved gas carrier to certify that satisfactory arrangements have been made to ensure the provision of underground gas services to each dwelling in the development shall be obtained prior to work commencing.

#### Stormwater Disposal

41. A detailed stormwater drainage plan(s), substantially in accordance with the approved concept stormwater drainage plan(s), shall be prepared and submitted to the Land & Housing Corporation. Any on-site detention system shall be designed in accordance with the relevant catchment authority's requirements (e.g. the Upper Parramatta River Catchment Trust On-site Detention Handbook) and/or Campbelltown City Council's drainage code.

#### **DURING DEMOLITION AND CONSTRUCTION WORKS**

The following Identified Requirements are to be complied with whilst demolition and construction works are occurring on the site.

#### Landfill

- **42.** Where site filling is necessary, a minimum of 95% standard compacting shall be achieved and certified by a NATA registered Soils Lab.
- **43.** Land fill materials must satisfy the following requirements:
  - i. be Virgin Excavated Natural Matter (VENM);
  - ii. be free of slag, hazardous, contaminated, putrescible, toxic or radio-active matter; and
  - iii. be free of industrial waste and building debris.

#### Heritage

- 44. Historic and indigenous archaeological sites and relics are protected under the Heritage Act 1977 and National Parks and Wildlife Act 1974, respectively. Should any relics be uncovered during the course of the approved works, work must cease immediately in the affected area. Subsequently, in cases where historical items have been uncovered, the Department of Planning and Environment must be contacted.
- **45.** All workers / contractors on the site shall be informed of their obligations, under the Heritage Act and *National Parks and Wildlife Act 1974*, that it is illegal to disturb, damage or destroy a relic without the prior approval.

#### Demolition

- **46.** Any existing structures identified for demolition shall be demolished prior to commencement of the construction of the activity.
- **47.** Demolition shall be carried out in accordance with the appropriate provisions of AS 2601.
- **48.** Where materials containing asbestos are to be removed, demolition shall be carried out by a licensed contractor(s) who have current SafeWork NSW accreditation in asbestos removal.
- **49.** Removal of asbestos-based thermal or acoustic insulation, such as sprayed asbestos and asbestos-based lagging, including friable asbestos boards, shall be carried out in accordance with the National Occupational Health and Safety Commission's Code of Practice for the Safe Removal of Asbestos, 2<sup>nd</sup> Edition [NOHSC:2002 (2005)].
- **50.** Hazardous or intractable wastes, including all asbestos laden waste, arising from the demolition process shall be removed and disposed of in accordance with the requirements of SafeWork NSW and the Department of Planning and Environment.
- 51. Documentary evidence, in the form of tip receipts from an approved Waste Management Facility, shall be obtained by the demolition contractor and submitted to the Land & Housing Corporation demonstrating the appropriate disposal of the asbestos waste.

- **52.** Demolition procedures shall maximise the reuse and recycling of demolished materials in order to reduce the environmental impacts of waste disposal.
- **53.** During demolition, the public footpath and the public road shall not be obstructed by any vehicles. The public road and footpath shall be swept (not hosed) clean of any material, including clay, soil and sand.
- 54. All vehicles leaving the site with demolition materials shall have their loads covered and vehicles shall not track soil and other material onto the public roads and footpaths. The footpath shall be suitably protected against damage when plant and vehicles access the site. All loading of vehicles with demolished materials shall occur on site.

#### **Survey Reports**

55. Survey reports shall be submitted by the building contractor to the Land & Housing Corporation prior to the placement of the footings / slab and on completion of the dwellings to verify the correct position of the structures in relation to the allotment boundaries.

#### Hours of Demolition / Construction / Civil Work

**56.** Demolition / construction / civil work shall only occur on the site between the hours of 7.00am to 5.00pm Monday to Saturday with no work permitted on Sundays or public holidays.

#### **Excavation & Backfilling**

57. All excavations and backfilling associated with the demolition or erection of building(s) shall be executed safely and in accordance with appropriate professional standards. All such work shall be guarded and protected to prevent it from being dangerous to life or property.

#### **Pollution Control**

- **58.** Any noise generated during the construction of the development shall not exceed the limits specified in the July 2009 Interim Construction Noise Guidelines, published by the former Department of Environment and Climate Change.
- **59.** No fires shall be lit or waste materials burnt on the site.
- **60.** No washing of concrete forms or trucks shall occur on the site.
- 61. Any contamination / spills on the site during construction works shall be actively managed and reported immediately to appropriate regulatory authorities to minimise any potential damage to the environment.
- **62.** Dust generation during demolition / construction shall be controlled using regular control measures such as on site watering or damp cloth fences.
- **63.** All vehicles transporting loose materials and travelling on public roads shall be secured (i.e. closed tail gate and covered) to minimise dust generation.

64. Non-recyclable waste and containers shall be regularly collected and disposed of at a licensed landfill or other disposal site in accordance with details set out in the final Waste Management Plan.

#### Impact of Construction Works

- **65.** The Land & Housing Corporation shall bear the cost of any necessary adjustments to utility mains and services.
- 66. Care shall be taken to prevent any damage to adjoining properties. The building contractor shall be liable to pay compensation to any adjoining owner if, due to demolition/construction works, damage is caused to such adjoining property.

#### **Termite Protection**

67. To protect buildings from subterranean termite, termite barriers installed in accordance with AS 3660.1, shall be placed on the underside and in penetrations of the concrete slab floor.

In addition, a durable notice must be permanently fixed inside the meter box indicating:

- (a) the method of protection,
- (b) the date of installation of the system.
- (c) where a chemical barrier is used, its life expectancy as listed on the National Registration Authority label, and
- (d) the need to maintain and inspect the system on a regular basis.

#### PRIOR TO OCCUPATION OF THE DEVELOPMENT

The following Identified Requirements are to be complied with prior to the occupation of the development.

#### General

68. The use or occupation of the development shall not commence until all the Identified Requirements of this determination have been complied with.

#### Council Infrastructure Damage

**69.** The cost of repairing any damage caused to Campbelltown City Council's assets in the vicinity of the site as a result of demolition / construction works shall be met in full by the building contractor.

#### Stormwater Drainage

- 70. Prior to occupation, a Work As Executed Plan shall be prepared by the building contractor clearly showing all aspects of the constructed stormwater drainage system, including any on-site detention system. The plan shall demonstrate general compliance with the approved concept stormwater drainage plan(s) and shall include:
  - sufficient levels and dimensions to verify the constructed storage volumes; and
  - location and surface levels of all pits; and

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- invert levels of the internal drainage lines, orifice plates fitted and levels within the outlet control pits; and
- finished floor levels of all structures; and
- verification that any required trash screens have been installed; and
- locations and levels of any overland flow paths; and
- verification that any drainage lines are located wholly within easements, where applicable.

The Work-As-Executed Plan information shall be shown on the final civil works drawings.

A positive covenant and restriction-as-to-user shall be placed over the onsite detention system in accordance with Campbelltown City Council's on-site detention policy to ensure that the system will be adequately maintained. The positive covenant and restriction-as-to-user shall be registered at NSW Land Registry Services prior to occupation. A copy of the registered restriction-as-to-user shall be provided to the Land & Housing Corporation and Campbelltown City Council.

#### PART B – Additional Identified Requirements

#### Site Specific Requirements

- 71. To manage bush fire risk and comply with Planning for Bushfire Protection 2019 (PBP), the development shall comply with the following requirements as outlined in the Bushfire Protection Assessment prepared by Travers Bushfire & Ecology dated 20 December 2022:
  - a. The development is as generally indicated on Schedule 1 of the bushfire protection assessment.
  - b. Building construction standards for the proposed construction within 100m of bushfire prone land are to be applied in accordance with AS3959 Construction of buildings in bushfire prone areas (2018) and PBP. The recommended construction standard is minimum BAL 12.5.
  - c. Water, electricity and gas supply is to comply with Section 5.3.3 of PBP.
  - d. Fencing is to comply with Section 7.6 of PBP. All fences in bush fire prone areas should be made of either hardwood or non-combustible material. In circumstances where the fence is within 6m of a building or in areas of BAL 29 or greater, they should be made of non-combustible material only.
- 72. Fencing provided along the side and rear boundaries is to comply with the following:
  - Be no more than 1.8m in height.
  - Where within 5.5m of the front boundary, fencing must be semi-transparent (i.e. not solid colorbond) and be no more than 1.2m in height.
- 73. An appropriate replacement tree must be incorporated into the Landscape Plan to compensate for the loss of T3, located in the front setback. The replacement tree must be a species nominated by a registered landscape architect as being appropriate species and size for the location. The replacement tree must be semi-mature height at the time of planting.
- **74.** Trees shown on the Landscape Plan prepared by Site Image dated 03/04/2023 that have a mature height of 6m or greater must be located no less than 3m from a building.

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- 75. The privacy screens provided to the living room windows on the northeast elevation of Rooms 05 & 07, and northwest elevation of the balcony off Room 07 are not required to mitigate privacy impacts and are therefore to be deleted to improve solar access to these internal areas.
- **76.** A site-specific Plan of Management (PoM) for the operation and management of the proposed boarding house development, including procedures for handling neighbour complaints, is to be prepared. The PoM is to be administered on site by the community housing provider responsible for managing the boarding house.
- 77. The maximum occupancy of each boarding room must not exceed 2 adult residents.
- **78.** The surface of the bin storage area is to be graded to drain towards the landscaped area located to the northwest.

#### Requirements Resulting from Council Comments

- **79.** A fixed privacy screen is to be provided to the northeast elevation of the balcony of Room 07 to prevent potential overlooking to the private open space of neighbouring properties.
- **80.** Council is to be contacted prior to the completion of construction works to discuss waste collection arrangements for the boarding house development.

#### **ADVISORY NOTES**

- i. Approval of this development activity does not imply or infer compliance with Section 23 of the *Disability Discrimination Act 1992*. Refer to AS 1428.1 and the Building Code of Australia for detailed guidance.
- ii. Information regarding the location of underground services may be obtained from Dial Before You Dig at <a href="https://www.1100.com.au">www.1100.com.au</a> or by dialing 1100.



#### **Decision Statement**

#### **Project No. BGWW7**

SITE IDENTIFICATION						
STREET ADDRESS						
Unit/Street No.	Street or property name Riverside Drive					
Suburb, town or locality Airds		Postcode 2560				
Local Government Area(s)  Campbelltown	Real property description (Lot and D	OP)				
ACTIVITY DESCRIPTION						
Provide a description of the activity						
Demolition (fence and concrete footpath), removal of trees and construction of a 2-storey boarding house comprising 8 self-contained rooms, a common room, parking for 2 vehicles (including 1 accessible space), 2 motorbikes and 4 bicycles, landscaping and fencing.						

The Land & Housing Corporation (LAHC) has proposed the above activity under the provisions of *State Environmental Planning Policy (Housing)* 2021 (Housing SEPP) which requires determination under Part 5 of the *Environmental Planning & Assessment Act* 1979 (EP&A Act). This Decision Statement relates to the Review of Environmental Factors (REF) for the above activity prepared under Part 5 of the EP&A Act and the *Environmental Planning and Assessment Regulation* 2021.

Based on the REF document, a decision to proceed with the proposed activity has been made. This decision included consideration of the following:

#### Significant Impact on the Environment

- The proposed activity is not likely to have a significant impact on the environment and therefore an EIS is not required.
- The proposed activity will not be carried out in a declared area of outstanding biodiversity value and is not likely to significantly affect threatened species, populations or ecological communities, or their habitats or impact biodiversity values, meaning a SIS and/or BDAR is not required.

#### Reasons for the Decision

- Following an assessment of the proposed activity and associated environmental impacts within the REF it was decided that the proposed boarding house development will have economic and social benefits and any minor short-term impacts on the environment or surrounding properties can be appropriately mitigated.
- The proposed boarding house development will assist LAHC in providing new, fit for purpose housing in the Campbelltown local government area which will assist in addressing the existing and growing demand for social housing in Campbelltown local government area.

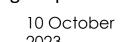
#### **Mitigation Measures**

 Mitigation measures are required to minimise or manage environmental impacts and are detailed throughout the REF and specifically within **Section 7**. All mitigation measures are detailed as Identified Requirements within the Activity Determination. Additional mitigation measures, detailed in the Activity Determination have been imposed to minimise the impact on the surrounding environment, ensure appropriate site safety and to ensure legislative compliance.

Signed.....

Dated 10 October 2023

Emma Nicholson
Acting Head of Policy and Innovation
Land and Housing Corporation
Department of Planning & Environment





# LAND AND HOUSING CORPORATION

189 RIVERSIDE DR, AIRDS, NSW 2560 LOT: 1216 / DP: 1183302 / DP: 609357 PROPOSED BOARDING HOUSING

**LOCATION MAP** 

ARC	HITECTURAL DOCUMENTS LIST		CONSULTANT LIST
ARCHITECTURAL		ARCHITECT	TONY GRAY 5303 CRAWFORD ARCHITECTS PTY LTD
20035 - A001	COVER SHEET		SUITE 3.01, LEVEL 3, 80 MOUNT STREET
20035 - A002	SITE ANALYSIS PLAN		NORTH SYDNEY NSW 2060 AUSTRALIA ABN 56 120 779 106
0035 - A002	TREE ANALYSYS PLAN		ABN 30 120 779 100
	DEEP SOIL AREA AND COS ANALYSIS		P 02 9660 3644 F 02 9660 3622
0035 - A015			
0035 - A100	EXISTING SITE SURVEY	PROJECT MANAGER	LAND & HOUSING CORPORATION
0035 - A101	SITE PLAN		LEVEL 3, 31 MACQUARE ST, PARRAMATTA
0035 - A200	GROUND FLOOR GENERAL LAYOUT PLAN		P 02 8753 8000 F 02 8753 8888
0035 - A201	FIRST FLOOR GENERAL LAYOUT PLAN		
20035 - A202	ROOF PLAN	STRUCTURAL & CIVIL	MICHAEL ELL CONSULTING ENGINEERS PTY LTD
0035 - A203	CUT AND FILL PLAN	CONSULTANT	5/1 MAXIM ST, WEST RYDE NSW 2114
0035 - A300	EXISTING AND PROPOSED STREET VIEWS		
20035 - A301	ELEVATIONS		P 02 9807 5355
0035 - A310	SECTIONS		
		ELECTRICAL	MARLINE NEWCASTLE PTY LTD
0035 - A500	3D VIEWS AND FINISHES SCHEDULE	CONSULTANT	UNIT F 56 CLYDE STREET, HAMILTON NORTH NSW2292
0035 - A501	ROOM TYPE SCHEDULE	_	HAWIETON NORTH NOWZZYZ
0035 - A510	SOLAR ACCESS GROUND FLOOR PLAN		P 02 4925 9300
0035 - A511	SOLAR ACCESS FIRST FLOOR PLAN	LIVERALILIE	MADI INE NEWOASTI E DTV I TO
0035 - A520	SHADOW DIAGRAMS	HYDRAULIC CONSULTANT	MARLINE NEWCASTLE PTY LTD UNIT F 56 CLYDE STREET, HAMILTON NORTH NSW2292
			P 02 4925 9300
		BASIX	DAMIAN O'TOOLE TOWN PLANNING STUDIO 9, LEVEL 5, BUCKINGHAM STREET SURRY HILLS NSW 2010
			P 02 9690 0464
		LANDSCAPE CONSULTANT	SITE IMAGE LANDSCAPE ARCHITECTS 1/3-5 BAPTIST ST REDFERN NSW 2016
			P 02 8332 5600
		MECHANICAL CONSULTANT	MARLINE NEWCASTLE PTY LTD UNIT F 56 CLYDE STREET, HAMILTON NORTH NSW2292
			P 02 4925 9300
		ARBORIST	ANDERSON ENVIRONMENTAL PTY LTD SUITE 19, 103 GEORGE STREET, PARRAMATTA 2150
			P 1300 302 507 F 0413 040394
		ACCESSIBILITY	LINDSAY PERRY PO BOX 453, NEW LAMBTON NSW 2305
			M 0418 909 180
		BCA	KIERAN TOBIN - BCA VISION 6A, 43A FLORENCE ST, HORNSBY NSW 2077
			P 9476 8613 M 0448 614 413
		BUSHFIRE CONSULTANT	TRAVERS BUSHFIRE & ECOLOGY MORGAN JEFFERY
			BUILDING, 52 THE AVENUE, KARIONG NSW 2250 P 4340 5331 M 1300 896 998
		_	
		_	
		$\dashv$	



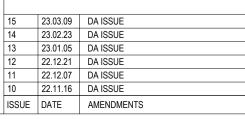


	DEVELOPMENT DATA						
Job Reference				BGWW7			
Locality / Suburb		Airds					
Street Address	189 Riverside Drive / Elizabeth Walk						
Lot Number(s) & Deposited Plan		1216	6 (D.P.118330	02) / Elizabeth Walk	(D.P.609357	)	
SITE AREA PROPOSED (sqm)				741.11			
NUMBER OF EXISTING LOTS				1			
PROPOSED GFA (sqm)				411.07			
NUMBER OF DWELLINGS			8 ro	oms - 8 Studios (100%)			
DWELLING AREAS	Unit no.	Туре	No. of Lodgers	Required room size (excl. wet areas)	Area (excl. wet areas)	Total (sqm)	POS (so
	1	Ground	1		25	38.54	28.12
	2	Ground	1		25	36	15.9
	3	Ground	1	Min. 12m2	25	36.16	19.23
	5	Ground 1st	1 1	(single lodger)	25 25	36 38.54	11.4 <sup>-</sup> 9
	6	1st	1	Max. 25m2	25	36.54	8.18
	7	1st	<u>'</u> 1		25	36.16	8.02
	8	1st	1		25	36	8.02
		Control	Re	equirement		Proposed	
BUILDING HEIGHT	Hous	ing SEPP		9m		7.64m	
LOT SIZE	Hou	sing SEPP		600sqm		741.11sqm	
FSR	Campl	belltown LEP		0.55:1	0.55		
PARKING	Housing SEPP	Accessible	8 x 0.2	= 1.6 car spaces		2 spaces	
MOTORCYCLE & BICYCLE PARKING	G Housing SEPP		(Bicycle: Apply the rates for an RFB under the Campbelltown DCP which is 1 space per 5 units.		4 bicycle spaces 2 motorbike spaces		
	Campbelltow n Sustainable City DCP Vol.1 (Boarding			1 space per 5 rooms) 5.5m required for MDH under DCP)		3.91m	
SETBACKS			0.9m (ground) 1.5m (above ground level) (Note: Min 0.9m required for MDH under DCP)		1.5m		
	houses s.17.2.3)	Rear Setback	5m (ground) 10m (above ground level) (note: Min 4m/ground floor and 6m/upper floor required for MDH under DCP)		4m		
COMMUNAL LIVING AREA	Housing SEPP		,	34m2 2 + 2m2 per room > 6 nin. dimension 3m)	34.11sqm		
COMMUNAL OPEN SPACE	Housing SEPP			site area, min. dim. 3m) 148.22sqm)	) 152.76sqm (20.61%)		%)
DEEP SOIL	Housing SEPP (Part 2, Division 2, clause 24(2))			% of site area 11.17sqm)	152.13 (20.53%)		)
LANDSCAPED AREA	Housing SEPP (Part 2, Division 2, clause 24(2))		line surfac	area forward of building ced with impervious materials	(28%) impervious materials		terials
SOLAR ACCESS	HOUS	SING SEPP		en 9am & 3 pm 21 June Imunal living area		COMPLIES	
	LAHC dwel	LAHC dwelling requirements		70% of units must receive 3 hours solar access to living areas and private open space in mid-winter  62,5% of units achieve		nits achieve 3hrs	solar acc



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NORTH SYDNEY, NSW 2060 AUSTRALIA






**BOARDING HOUSING** LOT: 1216 / DP:1183302 189 RIVERSIDE DR, AIRDS, NSW 2560

**COVER SHEET** 







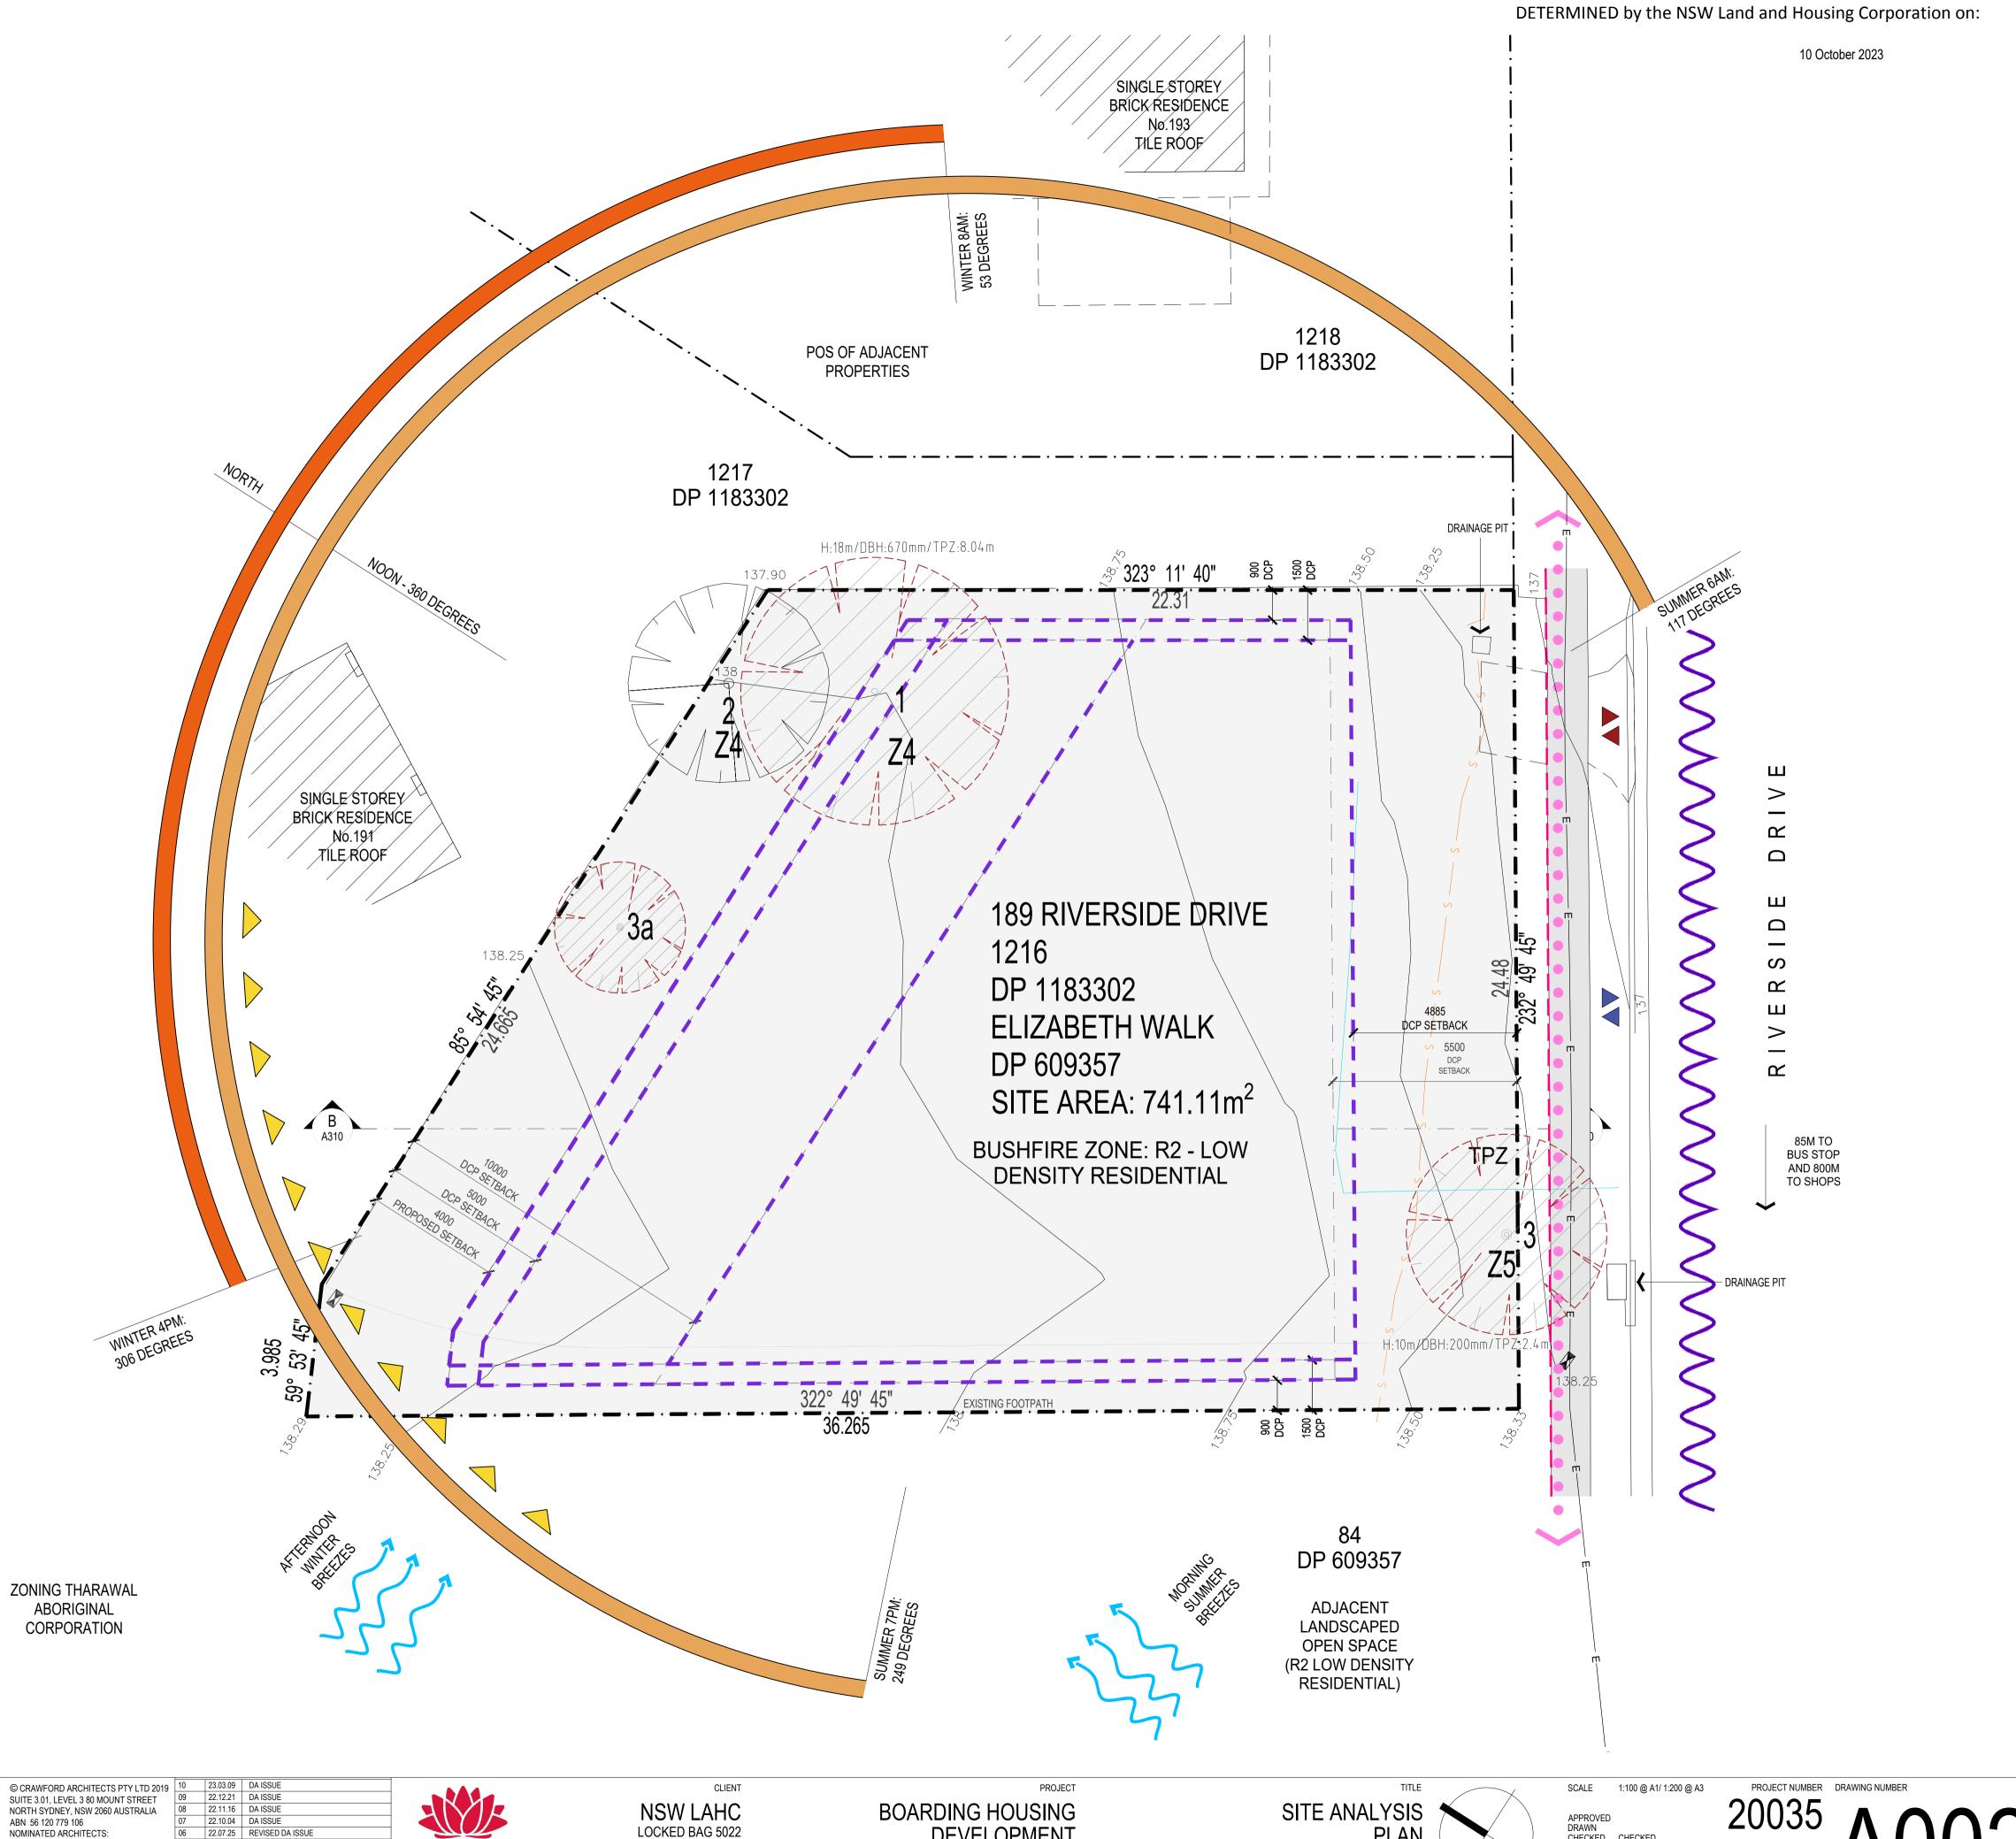

**WWW** NOISE SOURCE BREEZE DIRECTION GREATEST SOLAR HEAT GAIN TREE: EXISTING TO BE RETAINED  $\sim\sim$ TREE: EXISTING TO BE REMOVED PEDESTRIAN ACCESS VEHICLE ACCESS — — ACTIVE STREET FRONTAGE TREE TPZ

KEY

SEWAGE

STORMWATER LINE

PEDESTRIAN MOVEMENT

SITE BOUNDARY

Assessor Riley Coulson Accreditation No. HERA10174 Address RIVERSIDE DRIVE, Airds, NSW, 2560

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SUITE 3.01, LEVEL 3 80 MOUNT STREET NORTH SYDNEY, NSW 2060 AUSTRALIA NOMINATED ARCHITECTS: TONY GRAY 5303 & PAUL GODSELL 6726

22.07.25 REVISED DA ISSUE 22.05.18 REVISED DA ISSUE 22.04.13 DA ISSUE 22.04.05 CONSULTANT ISSUE ISSUE DATE AMENDMENTS

PARRAMATTA NSW 2124 PHONE: 1800 738 718

DEVELOPMENT LOT: 1216 / DP:1183302 189 RIVERSIDE DR, AIRDS, NSW 2560

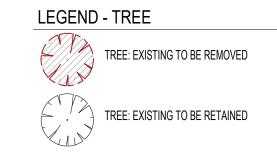


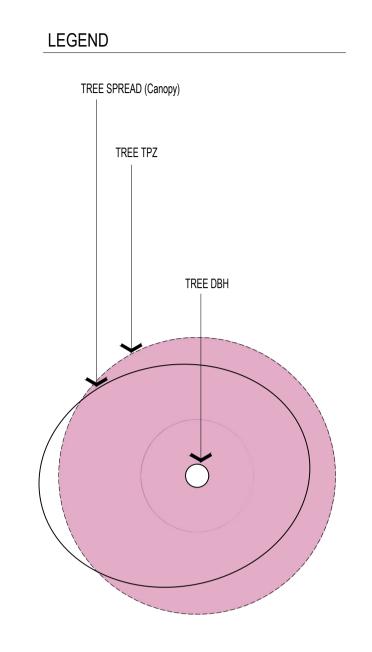
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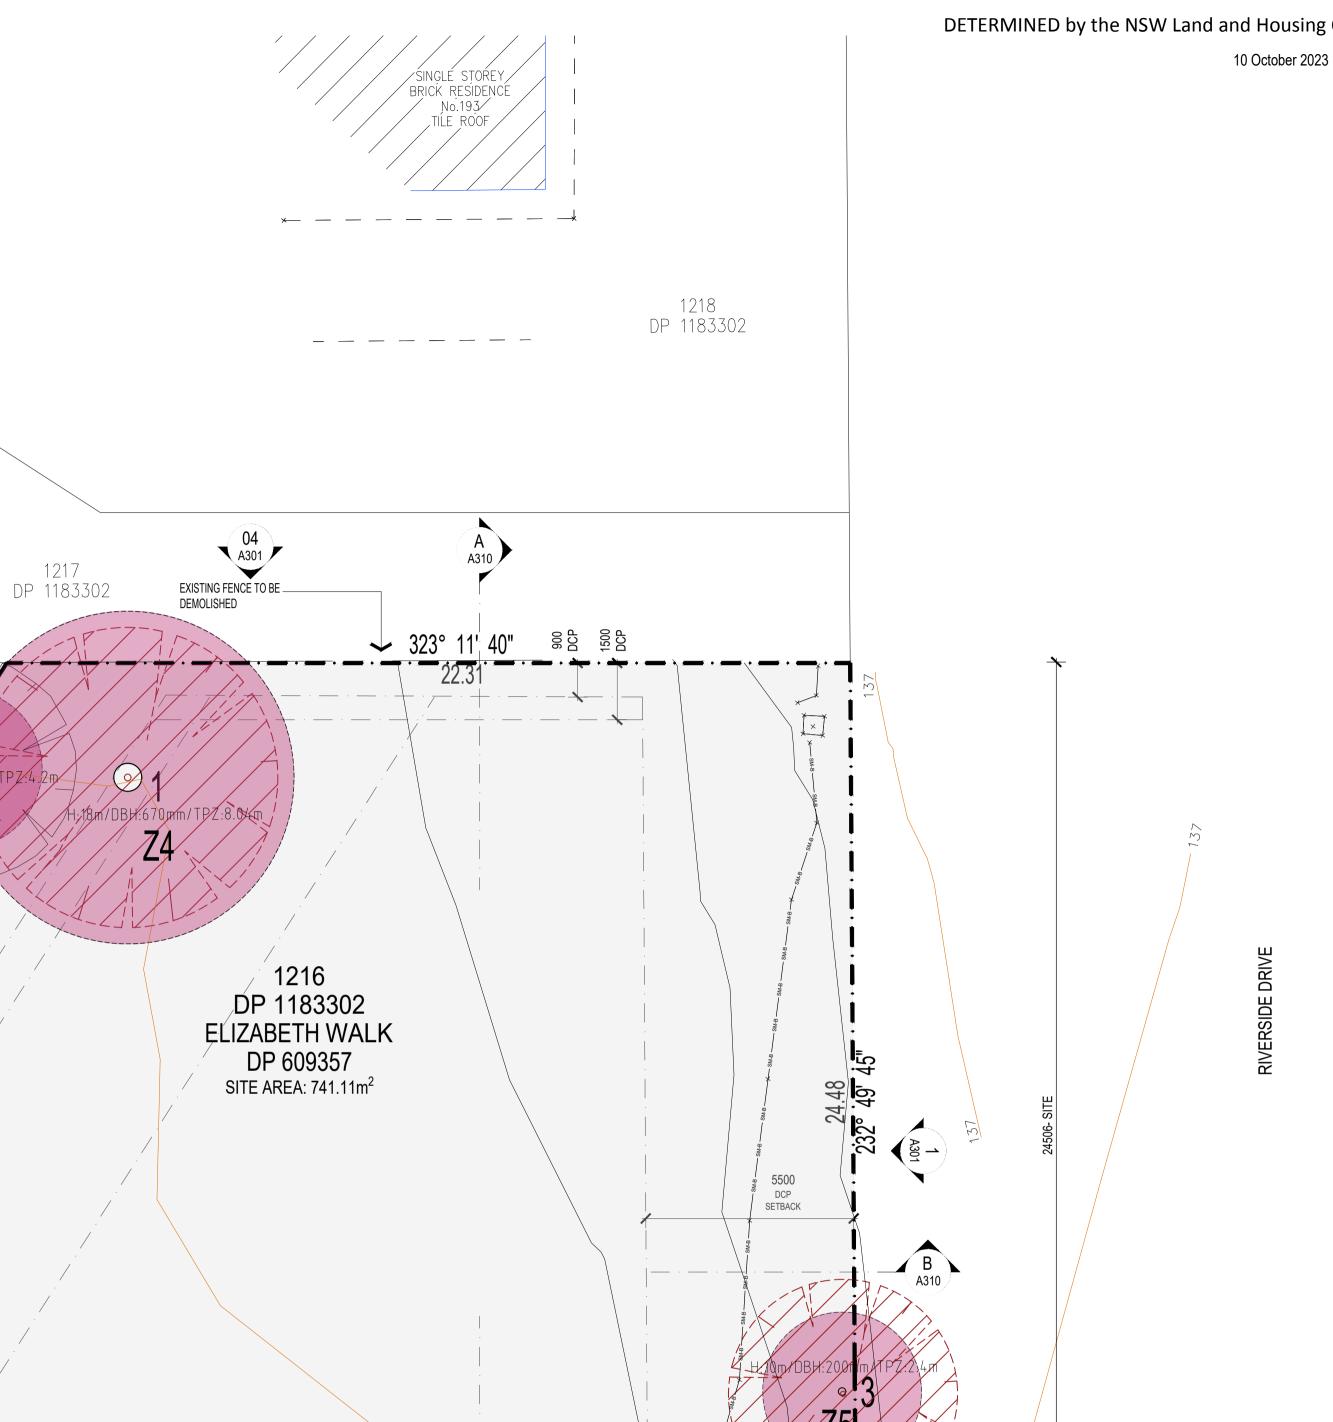
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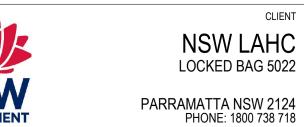
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22.04.13 DA ISSUE 22.04.05 CONSULTANT ISSUE ISSUE DATE AMENDMENTS

EXISTING FENCE TO BE DEMOLISHED

EXISTING FENCE TO BE DEMOLISHED



CONCRETE FOOTPATH TO BE - REMOVED

PROJECT **BOARDING HOUSING** DEVELOPMENT

03 A301

322° 49' 45". 36.265





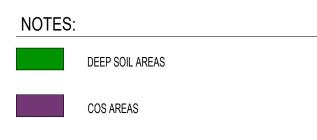
DATE OCT 2020

STATUS DA



10 October 2023







	DEVEL	OPMENT DATA			
Job Reference	BGWW7				
Locality / Suburb		Airds			
Street Address	189 F	Riverside Drive / Elizab	eth Walk		
_ot Number(s) & Deposited Plan	1216 (D.P.1183302) / Elizabeth Walk (D.P.609357)				
SITE AREA PROPOSED (sqm)	741.11				
DEE	P SOIL CALCULATION	ZONE	AREA (m2)		
		1	26.46		
		2	54.66		
		3	20.11		
		4	17.49		
		5	33.41		
		TOTAL	152.13		
	Control	Requirement	Proposed		
DEEP SOIL	Housing SEPP (Part 2, Division 2, clause 24(2))	15% of site area (111.17sqm)	152.13 (20.53%)		



# **COMMON OPEN SPACE**

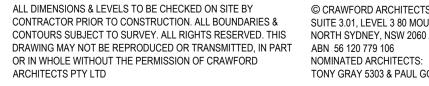
1: 26.46 m2

2: 87.78 m2

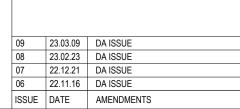
3: 38.52 m2

TOTAL: 152.76 m2 20.61%





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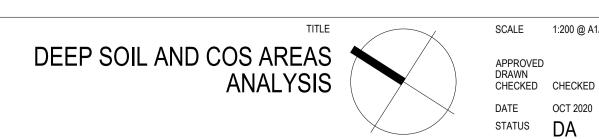





CLIENT NSW LAHC LOCKED BAG 5022 PARRAMATTA NSW 2124 PHONE: 1800 738 718

**BOARDING HOUSING** DEVELOPMENT LOT: 1216 / DP:1183302 189 RIVERSIDE DR, AIRDS, NSW 2560

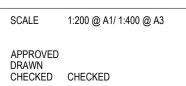PROJECT









BASED ON SITE SURVEY PREPARED BY TOTAL SURVEYING SOLUTIONS

# LEGEND - KEY

EXISTING STEEL BOLLARD TO BE DEMOLISH





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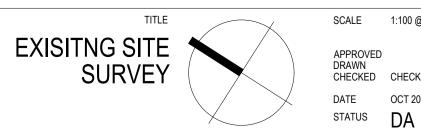
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CLIENT **NSW LAHC** LOCKED BAG 5022 PARRAMATTA NSW 2124 PHONE: 1800 738 718

PROJECT **BOARDING HOUSING** DEVELOPMENT LOT: 1216 / DP:1183302 189 RIVERSIDE DR, AIRDS, NSW 2560



SCALE 1:100 @ A1/ 1:200 @ A3 APPROVED DRAWN CHECKED CHECKED

PROJECT NUMBER DRAWING NUMBER DATE OCT 2020

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10 October 2023

LEGEND - TREE

TREE: EXISTING TO BE REMOVED

TREE: EXISTING TO BE RETAINED

LANDSCAPE

CARPARK

PATHWAY

COMMUNAL OPEN SPACE

PRIVATE OPEN SPACE (LANDSCAPED)



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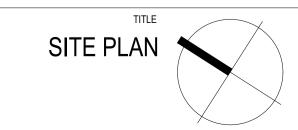
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**NSW LAHC** LOCKED BAG 5022 PARRAMATTA NSW 2124 PHONE: 1800 738 718

**BOARDING HOUSING** DEVELOPMENT LOT: 1216 / DP:1183302



SCALE 1:100 @ A1/ 1:200 @ A3 APPROVED DRAWN CHECKED CHECKED DATE OCT 2020
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LEGEND - TREE

TREE: EXISTING TO BE REMOVED

TREE: EXISTING TO BE RETAINED

COMMUNAL OPEN SPACE CARPARK

LANDSCAPE

PRIVATE OPEN SPACE (PAVED)

PRIVATE OPEN SPACE (LANDSCAPED)

PATHWAY LOBBY

LEGEND

POS

DEEP SOIL ZONE

WET AREAS HOT WATER UNIT

CLOTHES LINE

LETTER BOX REFRIGERATOR WASHING MACHINE

LINEN CUPBOARD BROOM CUPBOARD PANTRY

MAIN SWITCHBOARD CABLE TRANSITION LOCATION

GALVANISED STEEL BOLLARD

RAISED PLANTER BOX

PROPOSED PAVING

### NOTES: BUSHFIRE PROTECTION ASSESSMENT

REFER TO BUSHFIRE PROTECTION ASSESSMENT, DATE: 15/12/22 - FILE: 20PIE07

- RECOMMENDATION 1 - THE DEVELOPMENT IS AS GENERALLY INDICATED ON THE ATTACHED SCHEDULE 1 - PLAN OF BUSHFIRE PROTECTION MEASURES . - RECOMMENDATION 2 - APZS ARE TO BE PROVIDED TO THE PROPOSED DEVELOPMENT AS OUTLINED IN TABLE 2-2 AND AS GENERALLY DEPICTED WITHIN SCHEDULE 1 - RECOMMENDATION 3 - ACCESS IS TO COMPLY WITH THE ACCEPTABLE SOLUTIONS OUTLINED IN SECTION 5.3.2 OF PLANNING FOR BUSH FIRE PROTECTION 2019. - RECOMMENDATION 4 - BUILDING CONSTRUCTION STANDARDS FOR THE PROPOSED FUTURE DWELLINGS WITHIN 100M OF BUSHFIRE PRONE LAND ARE TO BE APPLIED IN ACCORDANCE WITH AS3959 CONSTRUCTION OF BUILDINGS IN BUSHFIRE PRONE AREAS (2018), AND PLANNING FOR BUSH FIRE PROTECTION 2019. THE RECOMMENDED CONSTRUCTION STANDARD IS MINIMUM BAL 12.5. - RECOMMENDATION 5 - WATER, ELECTRICITY AND GAS SUPPLY IS TO COMPLY WITH SECTION 5.3.3 OF PLANNING FOR BUSH FIRE PROTECTION 2019. - RECOMMENDATION 6 - FENCING IS TO COMPLY WITH SECTION 7.6 OF PBP. ALL FENCES IN BUSH FIRE PRONE AREAS SHOULD BE MADE OF EITHER HARDWOOD OR NON-COMBUSTIBLE MATERIAL. HOWEVER, IN CIRCUMSTANCES WHERE THE FENCE IS WITHIN 6M OF A BUILDING OR IN AREAS OF BAL 29 OR GREATER, THEY SHOULD BE MADE OF NON-COMBUSTIBLE MATERIAL ONLY.

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**BOARDING HOUSING** DEVELOPMENT LOT: 1216 / DP:1183302 189 RIVERSIDE DR, AIRDS, NSW 2560



SCALE 1:100 @ A1/ 1:200 @ A3 DRAWN CHECKED CHECKED

DATE OCT 2020

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LEGEND - TREE

TREE: EXISTING TO BE REMOVED

TREE: EXISTING TO BE RETAINED

\*REFER TO ARBORIST REPORT FOR TREE ASSESSMENT

DETAILS PREPARED BY ANDERSON ENVIRONMENTAL

LEGEND POS

PRIVATE OPEN SPACE (PAVED) PRIVATE OPEN SPACE (LANDSCAPED)

LANDSCAPE

COMMUNAL OPEN SPACE

CARPARK

PATHWAY

DEEP SOIL ZONE

WET AREAS HOT WATER UNIT **CLOTHES LINE** 

LETTER BOX REFRIGERATOR WASHING MACHINE LINEN CUPBOARD

BROOM CUPBOARD PANTRY

MAIN SWITCHBOARD CTL CABLE TRANSITION LOCATION

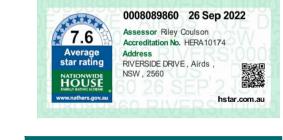
NOTES: BUSHFIRE PROTECTION **ASSESSMENT** 

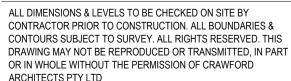
REFER TO BUSHFIRE PROTECTION ASSESSMENT, DATE: 15/12/22 - FILE: 20PIE07

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DP 609357

A310











03 A301

36.265




DATE OCT 2020


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NOMINATED ARCHITECTS:
TONY GRAY 5303 & PAUL GODSELL 6726

OS 22.11.16

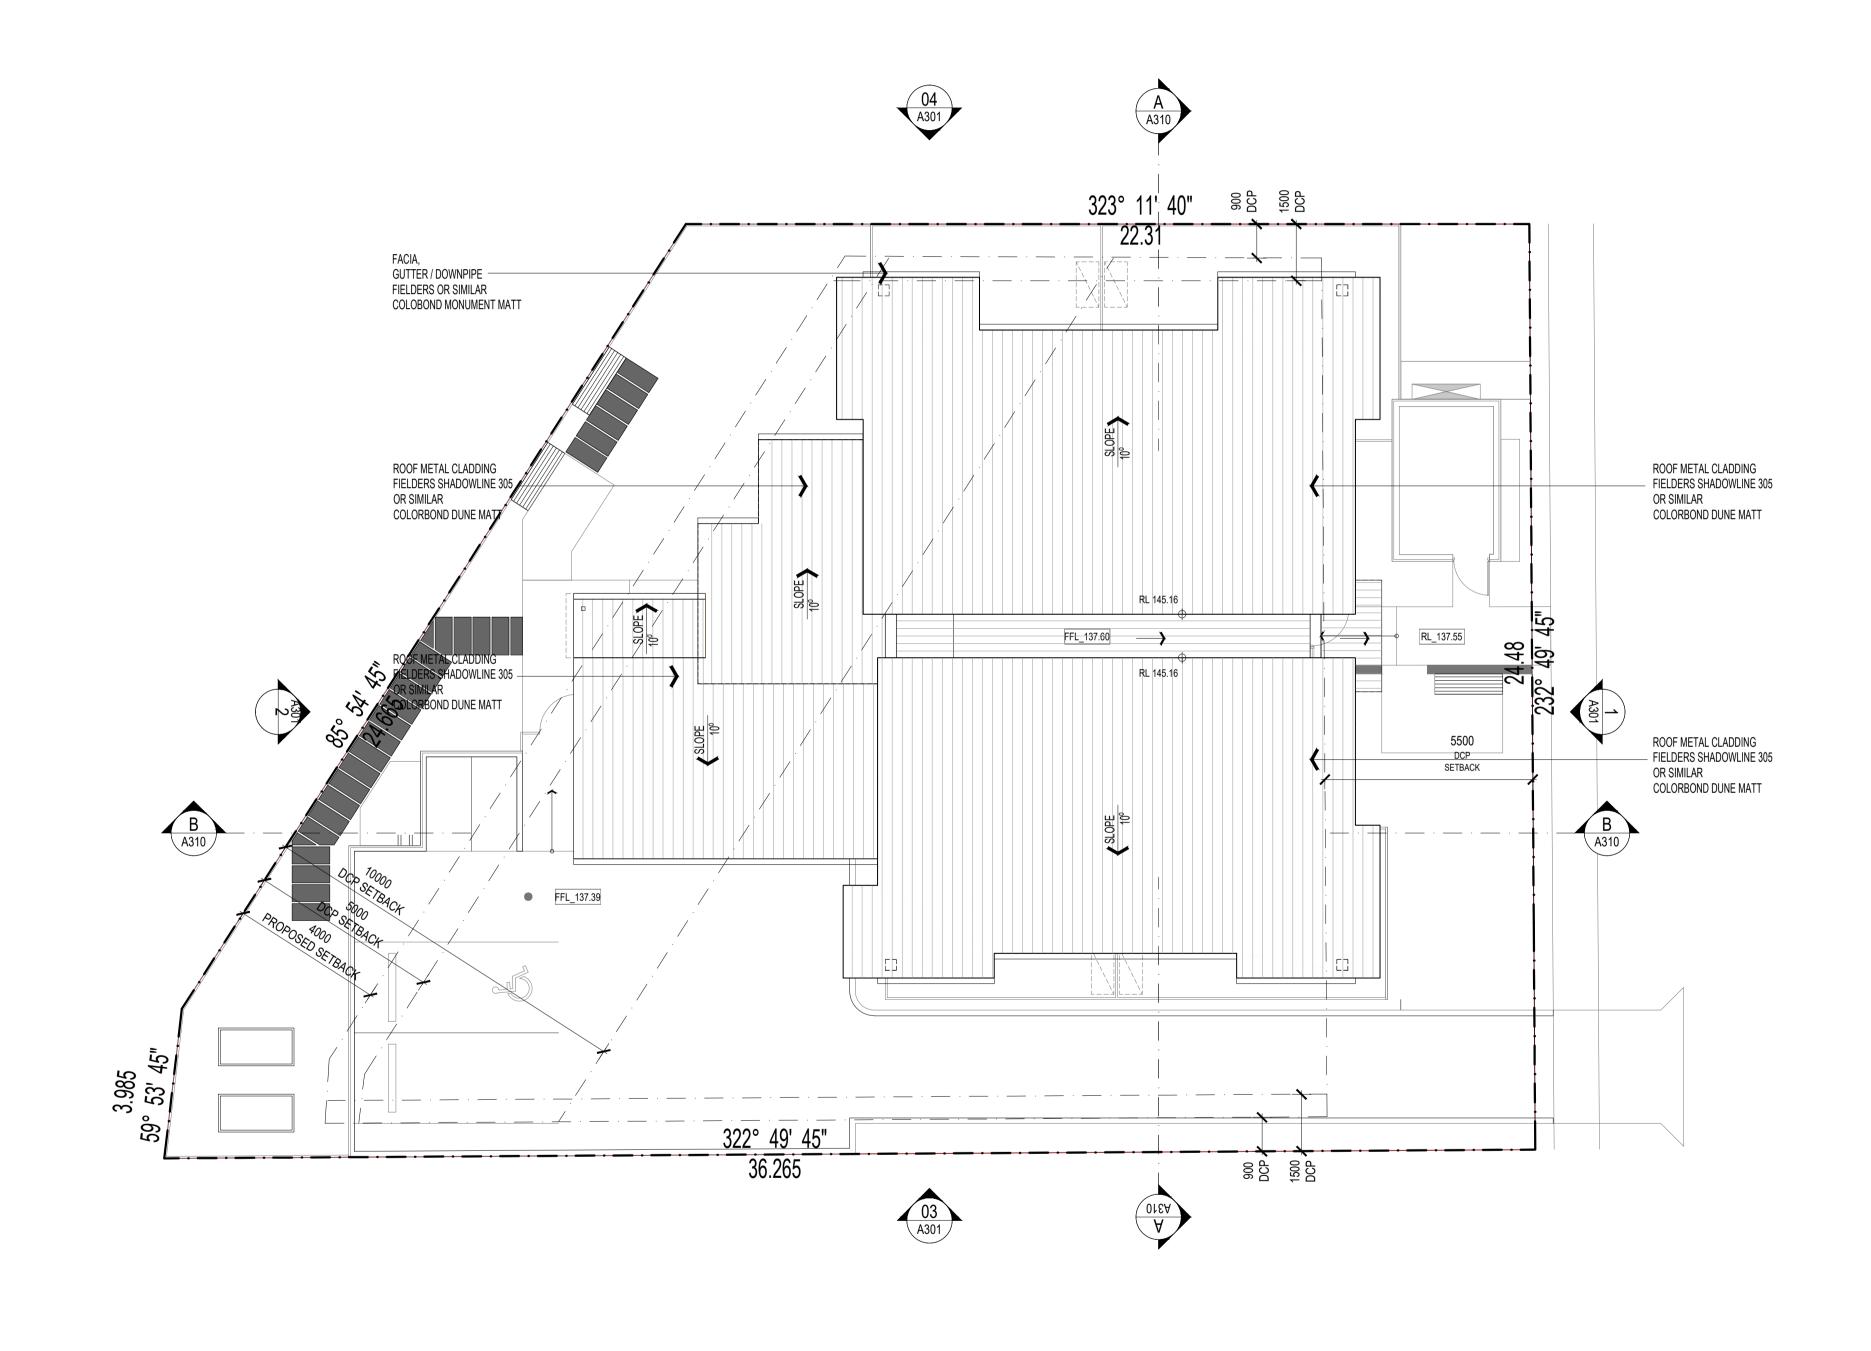OB 22.11.16

OB 22.11.16


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22.07.25

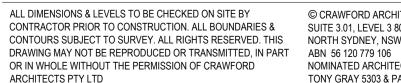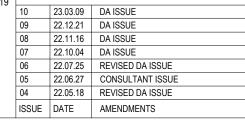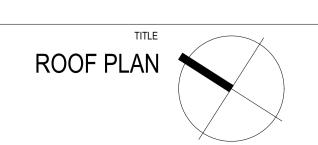
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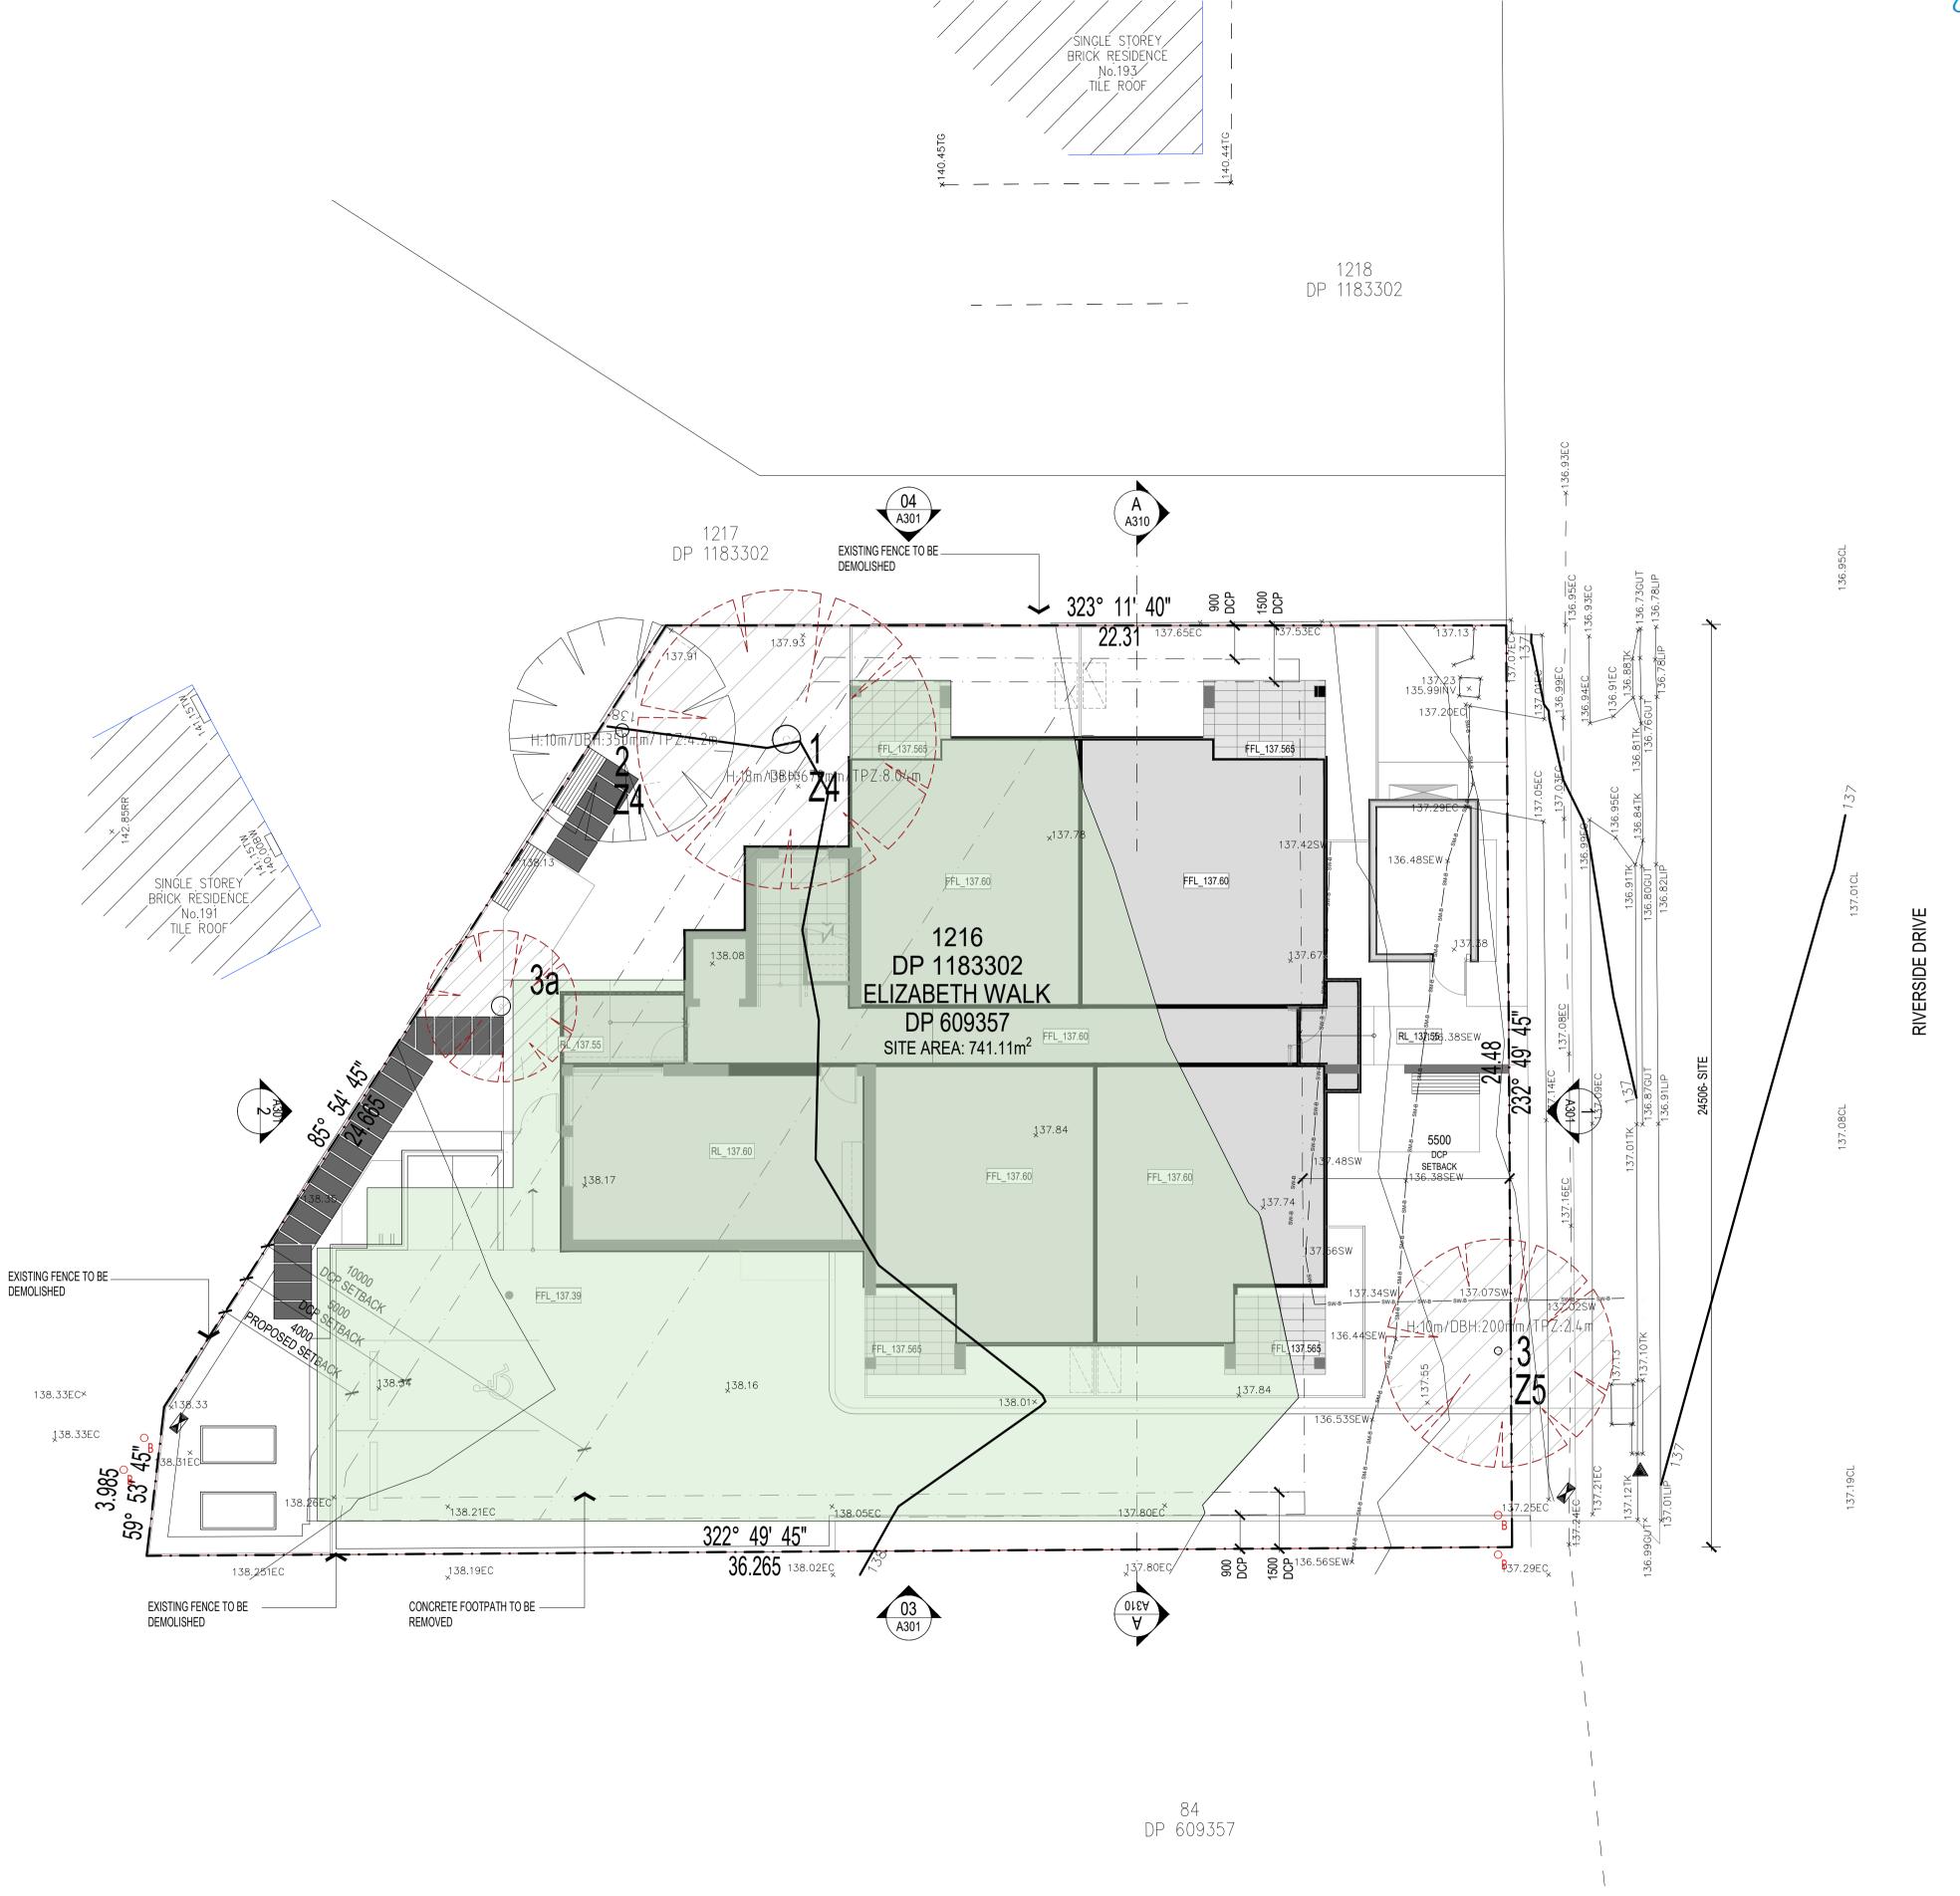














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CLIENT **NSW LAHC** LOCKED BAG 5022 PARRAMATTA NSW 2124 PHONE: 1800 738 718

PROJECT **BOARDING HOUSING** DEVELOPMENT LOT: 1216 / DP:1183302 189 RIVERSIDE DR, AIRDS, NSW 2560



SCALE 1:100 @ A1/ 1:200 @ A3 APPROVED DRAWN CHECKED CHECKED

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LEGEND

---- EXISTING GROUNDLINE

PROPOSED GROUNDLINE







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SUITE 3.01, LEVEL 3 80 MOUNT STREET

NOMINATED ARCHITECTS:

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NSW GOVERNMENT

PARRAMATTA NSW 2124 PHONE: 1800 738 718

**BOARDING HOUSING** DEVELOPMENT LOT: 1216 / DP:1183302 189 RIVERSIDE DR, AIRDS, NSW 2560

EXISTING AND PROPOSED STREET VIEWS

APPROVED DRAWN CHECKED CHECKED DATE OCT 2020 STATUS DA

PROJECT NUMBER DRAWING NUMBER



Address RIVERSIDE DRIVE , Airds , NSW , 2560

PARRAMATTA NSW 2124 PHONE: 1800 738 718

189 RIVERSIDE DR, AIRDS, NSW 2560

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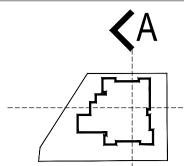
08 22.10.04 DA ISSUE


ISSUE DATE AMENDMENTS


Address RIVERSIDE DRIVE , Airds , NSW , 2560




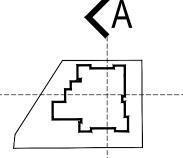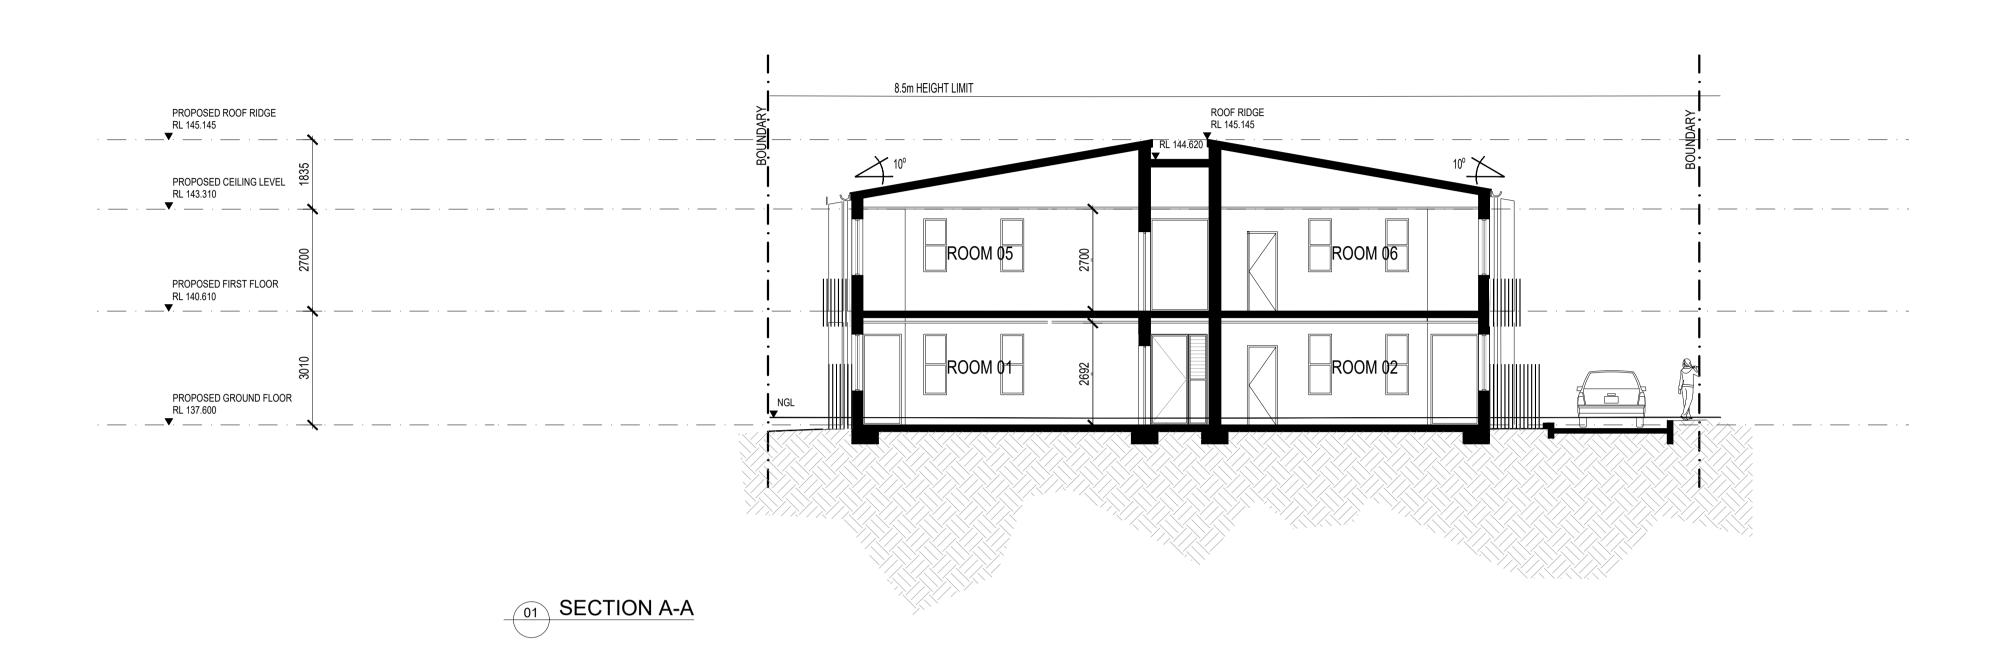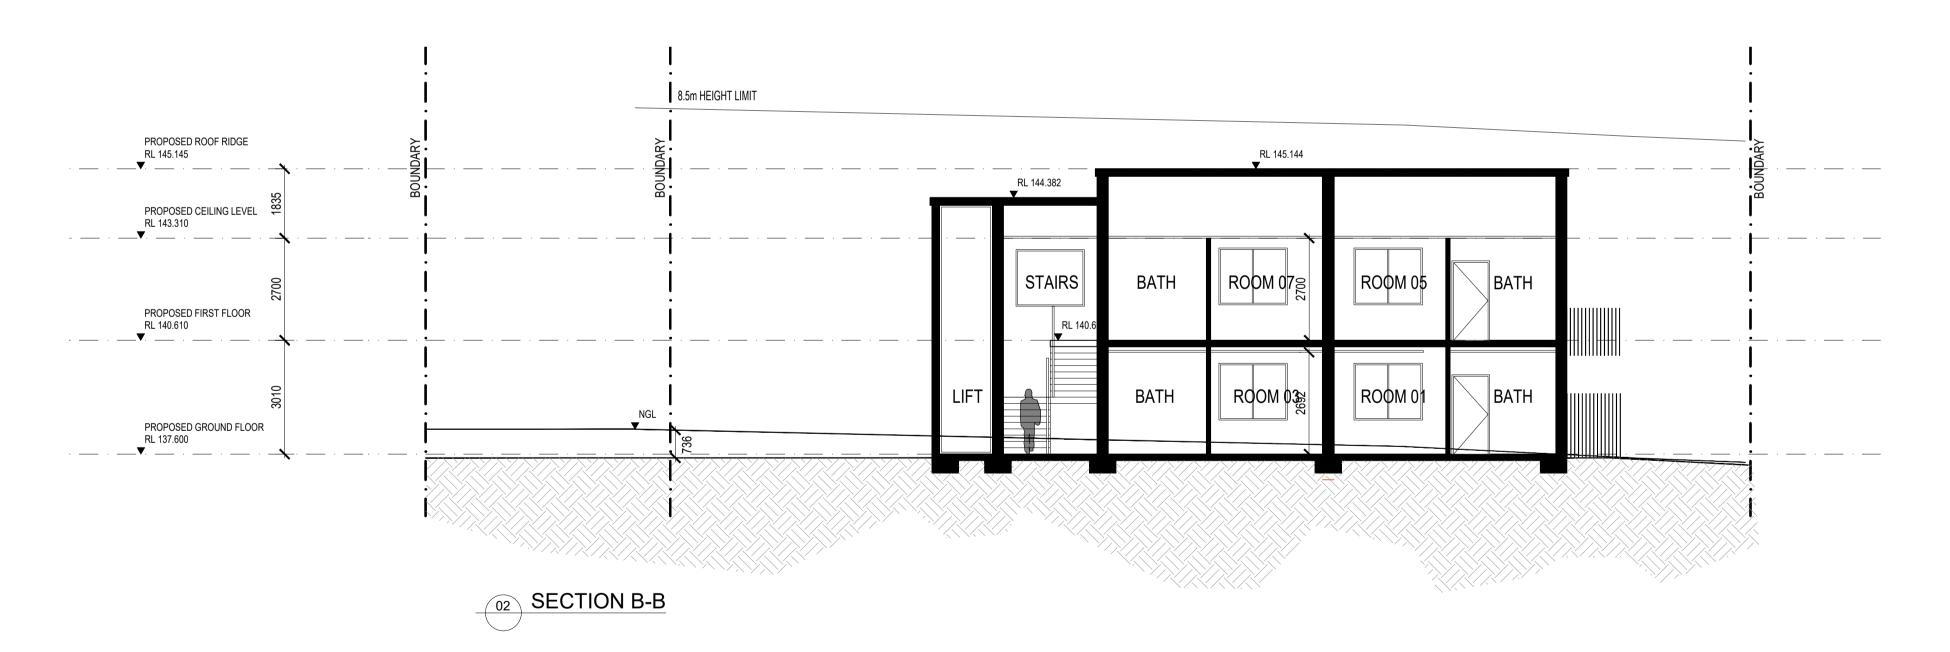LEGEND











APPROVED BY A DIRECTOR OF CRAWFORD ARCHITECTS PTY LTD E arch@crawford.com.au



ISSUE DATE AMENDMENTS













# 01 3D VIEW 01

# **EXTERNAL FINISHES**

ELEMENTS	MATERIALS	CODE	FINISHES / COLOUR / MANUFACTURER	
ROOF	METAL CLADDING	MC-1	FIELDERS SHADOWLINE 305 OR SIMILAR COLORBOND COLOUR: DUNE MATT	
FACIA, GUTTER / DOWNPIPE	METAL CLADDING	MC-2	FIELDERS OR SIMILAR  COLORBOND COLOUR: MONUMENT MATT	
WALLS	BRICK	BF-1	AUSTRAL BRICKS - NUBRIK ARTISAN - AURORA OR SIMILAR	
	BRICK	BF-2	AUSTRAL BRICKS - METALLIX - BLACKSTONE OR SIMILAR	
	RENDER	CF-1	DULUX COLOUR: TERRAIN	
WINDOW AND DOORS	ALUMINIUM FRAME WITH STANDARD LAMINATED GLASS TO BCA & BASIX	AF-1	COLORBOND COLOUR: MONUMENT MATT	
FENCING	STEEL FENCING	FF-1	COLORBOND FENCING COLOUR : DUNE	
WINDOW SHADES AND AWNING	ALUMINIUM AWNING	SF-1	HEKA HOODS CORE SERIES COLORBOND COLOUR : TERRAIN	
WINDOW SHADES AND AWNING	FIBRE CEMENT CLADDING	FC-1	POWDER COATED FINISH COLORBOND COLOUR : TERRAIN	

# **ASSESSMENT**

SCALE 1:100 @ A1

CHECKED CHECKED

DATE OCT 2020

STATUS DA

APPROVED

REFER TO BUSHFIRE PROTECTION ASSESSMENT, DATE: 15/12/22 - FILE: 20PIE07

- RECOMMENDATION 1 - THE DEVELOPMENT IS AS GENERALLY INDICATED ON THE ATTACHED SCHEDULE 1 - PLAN OF BUSHFIRE PROTECTION MEASURES . - RECOMMENDATION 2 - APZS ARE TO BE PROVIDED TO THE PROPOSED DEVELOPMENT AS OUTLINED IN TABLE 2-2 AND AS GENERALLY DEPICTED WITHIN SCHEDULE 1. - RECOMMENDATION 3 - ACCESS IS TO COMPLY WITH THE ACCEPTABLE SOLUTIONS OUTLINED IN SECTION 5.3.2 OF PLANNING FOR BUSH FIRE PROTECTION 2019. - RECOMMENDATION 4 - BUILDING CONSTRUCTION STANDARDS FOR THE PROPOSED FUTURE DWELLINGS WITHIN 100M OF BUSHFIRE PRONE LAND ARE TO BE APPLIED IN ACCORDANCE WITH AS3959 CONSTRUCTION OF BUILDINGS IN BUSHFIRE PRONE AREAS (2018), AND PLANNING FOR BUSH FIRE PROTECTION 2019. THE RECOMMENDED CONSTRUCTION STANDARD IS MINIMUM BAL 12.5. - RECOMMENDATION 5 - WATER, ELECTRICITY AND GAS SUPPLY IS TO COMPLY WITH SECTION 5.3.3 OF PLANNING FOR BUSH FIRE PROTECTION 2019. - RECOMMENDATION 6 - FENCING IS TO COMPLY WITH SECTION 7.6 OF PBP. ALL FENCES IN BUSH FIRE PRONE AREAS SHOULD BE MADE OF EITHER HARDWOOD OR NON-COMBUSTIBLE MATERIAL. HOWEVER, IN CIRCUMSTANCES WHERE THE FENCE IS WITHIN 6M OF A BUILDING OR IN AREAS OF BAL 29 OR GREATER, THEY SHOULD BE MADE OF NON-COMBUSTIBLE MATERIAL ONLY.



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NOMINATED ARCHITECTS: 08 22.12.07 DA ISSUE

TONY GRAY 5303 & PAUL GODSELL 6726 07 22.11.16 DA ISSUE DRAWING MAY NOT BE REPRODUCED OR TRANSMITTED, IN PART ABN 56 120 779 106

22.10.04 DA ISSUE 05 22.07.25 REVISED DA ISSUE

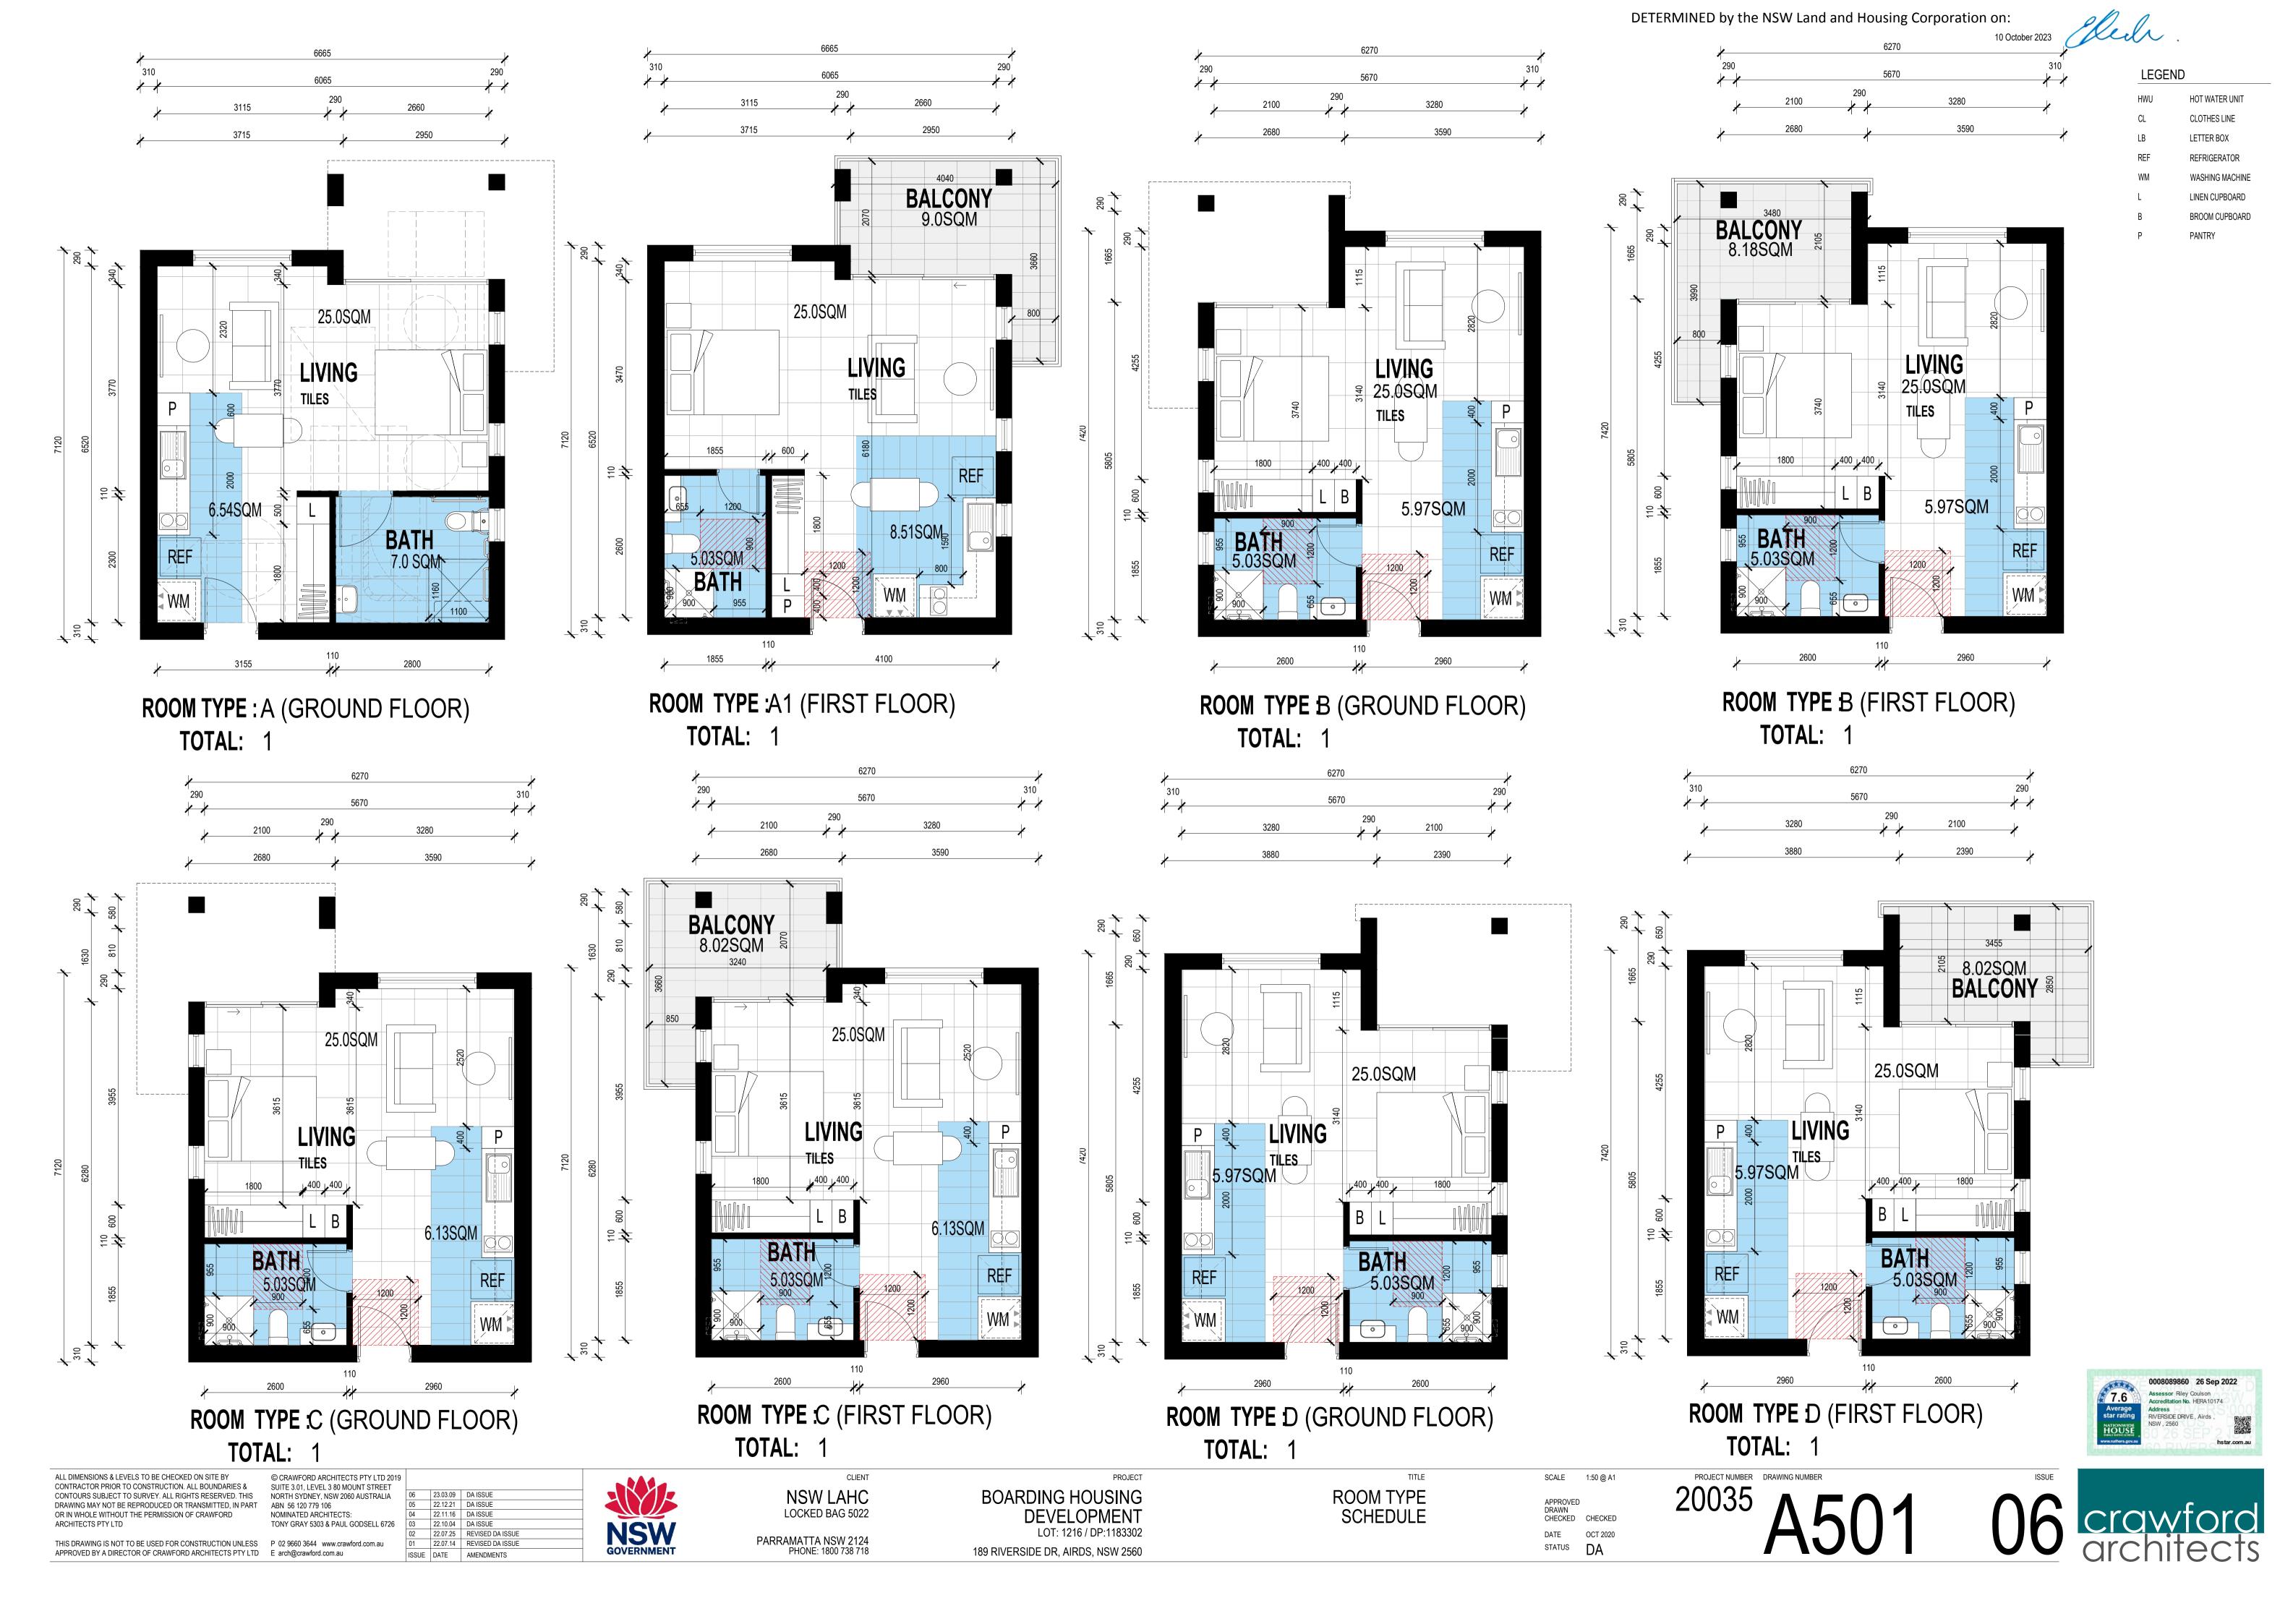
ISSUE DATE AMENDMENTS



**NSW LAHC** LOCKED BAG 5022 PARRAMATTA NSW 2124 PHONE: 1800 738 718

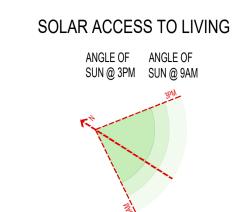
**BOARDING HOUSING** DEVELOPMENT LOT: 1216 / DP:1183302 189 RIVERSIDE DR, AIRDS, NSW 2560 3D VIEWS & FINISHES SCHEDULE

PROJECT NUMBER DRAWING NUMBER














SOLAR ACCESS TO POS

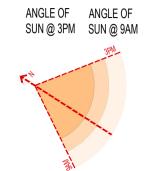

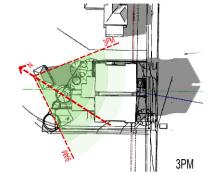

ANGLE CLARIFICATION

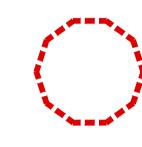LIMITED SOLAR ACCESS



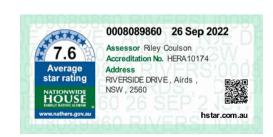
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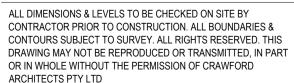


**DEVELOPMENT DATA** BGWW7 Job Reference **Airds** Locality / Suburb Street Address 189 Riverside Drive / Elizabeth Walk Lot Number(s) & 1216 (D.P.1183302) / Elizabeth Walk (D.P.609357) Deposited Plan SITE AREA 741.11 PROPOSED (sqm) SOLAR ACCESS CALCULATION UNIT AREA (m2)


	1	COMPLIES
	2	NON COMPLIANT
	3	COMPLIES
	4	NON COMPLIANT
	Requirement	Proposed
EPP	3 hours between 9am & 3 pm 21 June	COMPLIES

SOLAR ACCESS	HOUSING SEPP	3 hours between 9am & 3 pm 21 June to a communal living area	COMPLIES
	LAHC dwelling requirements	70% of units must receive 3 hours solar access to living areas and private open space in mid-winter	62,5% of units achieve solar acces







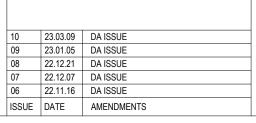







36.265

ROOM 04 ROOM 02



DATE OCT 2020

STATUS DA

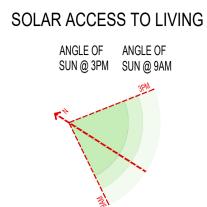
PROJECT NUMBER DRAWING NUMBER

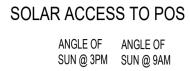


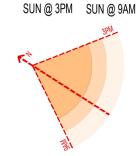
10 October 2023



ANGLE CLARIFICATION













#### **DEVELOPMENT DATA** BGWW7 Job Reference Airds Locality / Suburb 189 Riverside Drive / Elizabeth Walk Street Address Lot Number(s) & 1216 (D.P.1183302) / Elizabeth Walk (D.P.609357) Deposited Plan SITE AREA 741.11 PROPOSED (sqm) SOLAR ACCESS CALCULATION UNIT AREA (m2) COMPLIES NON COMPLIANT COMPLIES COMPLIES Control Requirement Proposed 3 hours between 9am & 3 pm 21 June HOUSING SEPP COMPLIES to a communal living area SOLAR ACCESS 70% of units must receive 3 hours 62,5% of units achieve 3hrs LAHC dwelling requirements solar access to living areas and

84 DP 609357



solar acces

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DRAWING MAY NOT BE REPRODUCED OR TRANSMITTED, IN PART ABN 56 120 779 106 NOMINATED ARCHITECTS:

23.01.05 DA ISSUE 22.12.21 DA ISSUE 22.12.07 DA ISSUE 22.11.16 DA ISSUE ISSUE DATE AMENDMENTS









1218 DP 1183302

323° 11' 40" 응합

ROOM 07



DATE OCT 2020

STATUS DA

PROJECT NUMBER DRAWING NUMBER

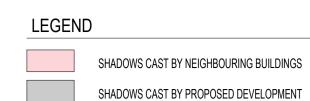
private open space in mid-winter

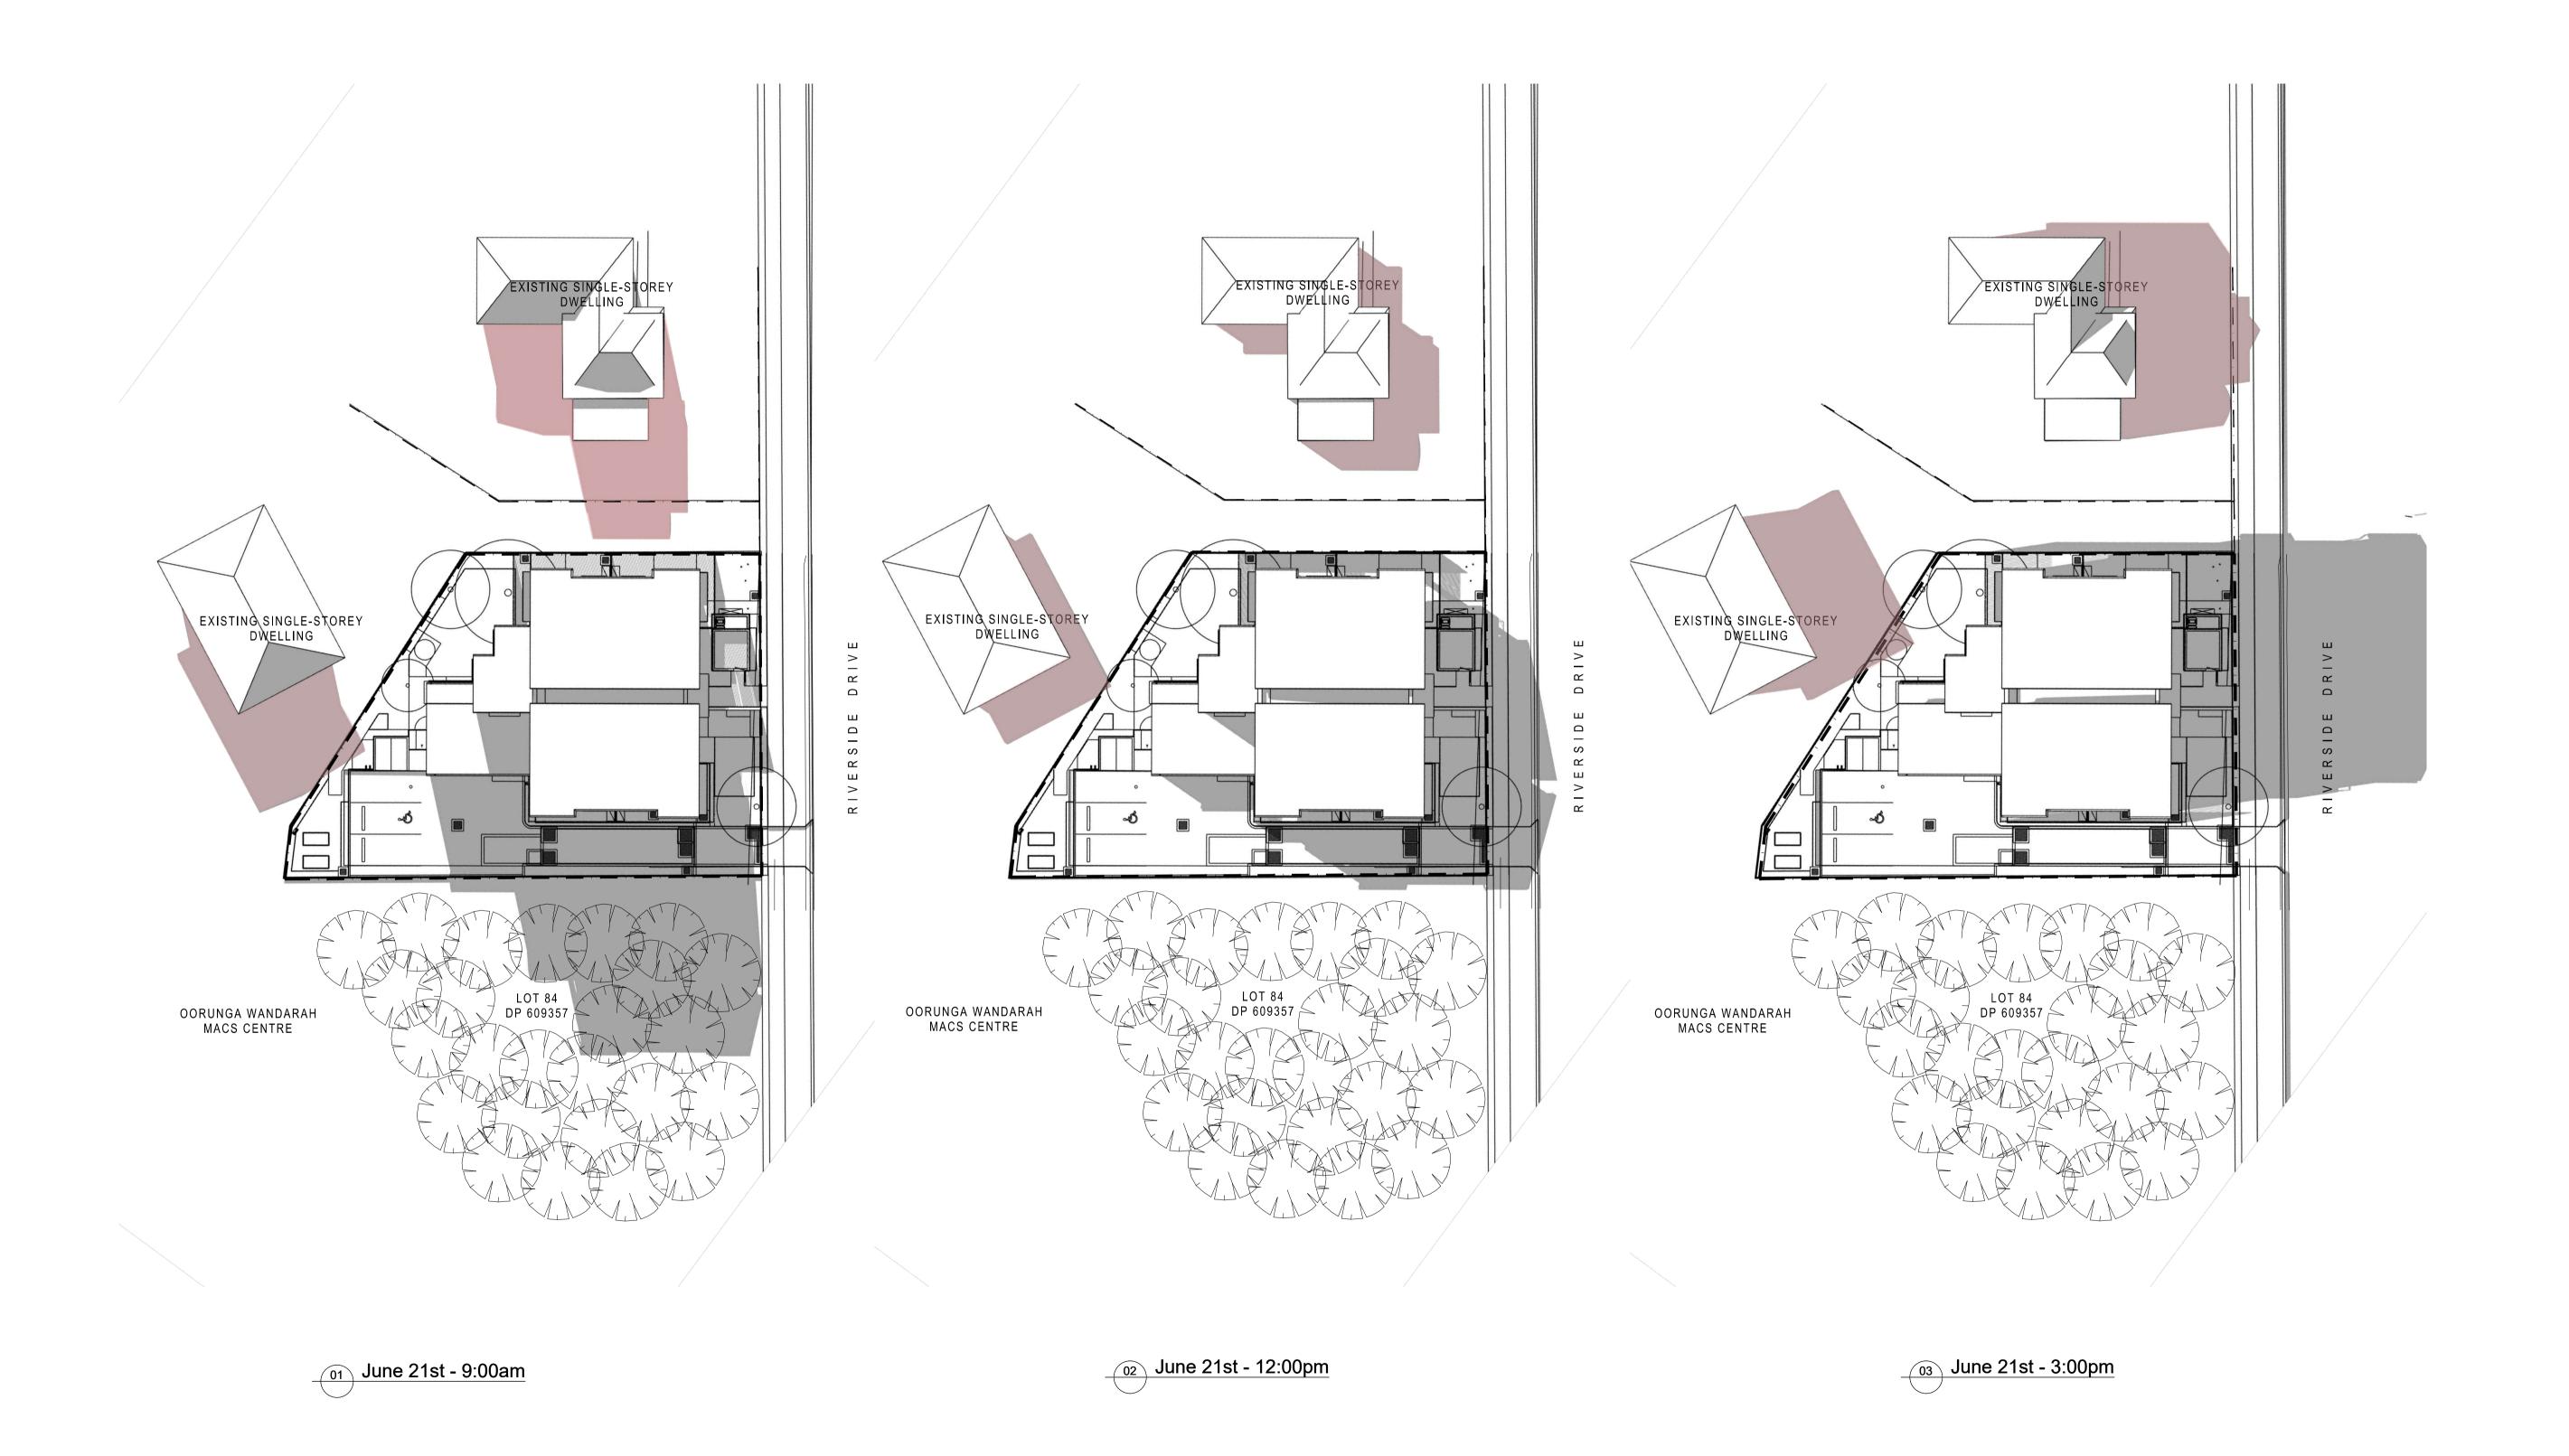
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1217 DP 1183302

[\_\_\_\_\_

322° 49' 45"







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SUITE 3.01, LEVEL 3 80 MOUNT STREET NOMINATED ARCHITECTS: TONY GRAY 5303 & PAUL GODSELL 6726

 
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 DA ISSUE

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 22.12.21
 DA ISSUE

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 22.12.07
 DA ISSUE
 22.11.16 DA ISSUE 05 22.10.04 DA ISSUE ISSUE DATE AMENDMENTS

NSW LAHC LOCKED BAG 5022 PARRAMATTA NSW 2124 PHONE: 1800 738 718

BOARDING HOUSING DEVELOPMENT LOT: 1216 / DP:1183302 189 RIVERSIDE DR, AIRDS, NSW 2560





DETERMINED by the NSW Land and Housing Corporation on:

LAHC Airds

10 October 2023

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1	Architectural Coordination	JD	NM	03.04.2023
Н	Hardstand Added to Seat	JD	NM	23.02.2023
G	Architectural Coordination	JD	NM	22.11.2022
F	Architectural Coordination	LW	NM	10.10.2022
Е	Architectural Coordination	LW	NM	04.10.2022
D	Architectural Coordination	RG	NM	14.07.2022
С	Architectural Coordination	RG	NM	07.07.2022
В	Architectural Coordination	RG	NM	18.05.2022
Α	Preliminary	MW	NM	14.04.2022
Issue	Revision Description	Drawn	Check	Date

Legend


# Drawing Schedule

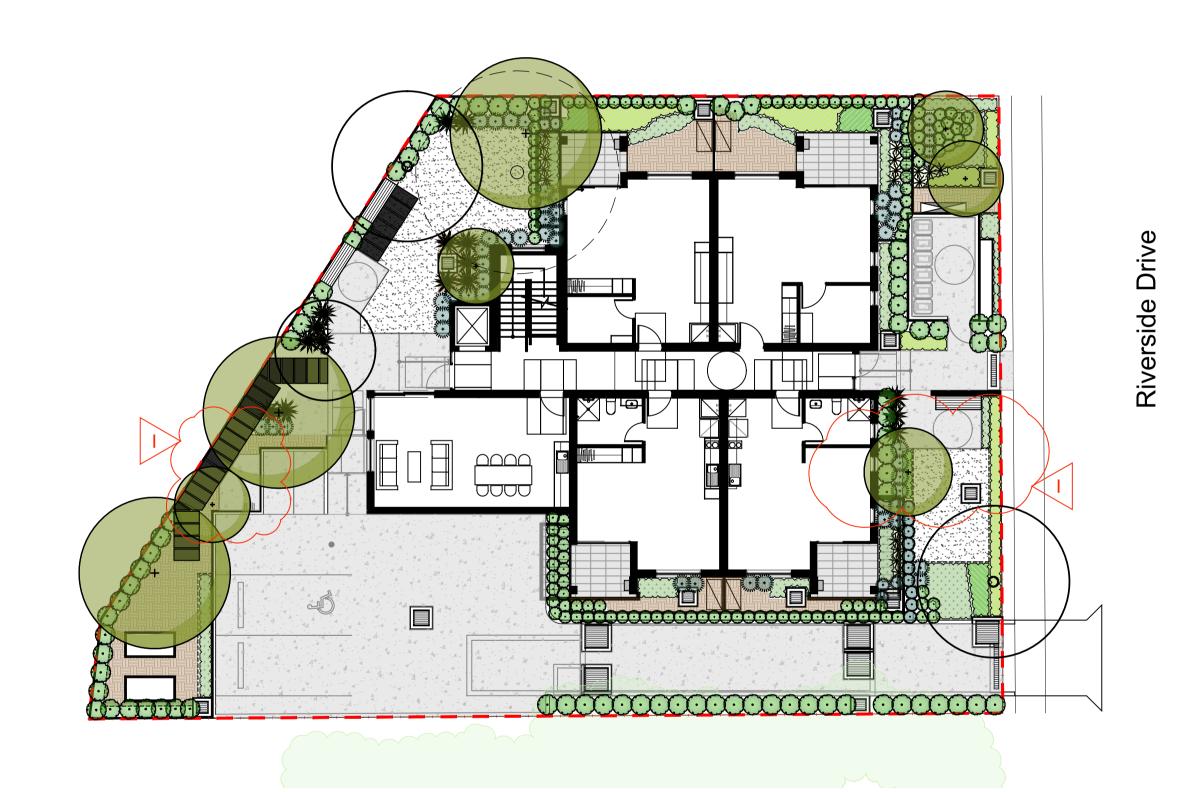Drawing Title	Scale
Landscape Coversheet	N/A
Landscape Plan	1:100
Landscape Deatils	As Shown
	Landscape Coversheet Landscape Plan


LANDSCAPE DEVELOPMENT APPLICATION

189 Riverside Drive, Airds, NSW 2560

Symbol	Botanic Name	Common Name	Height x Width (m)	Pot Size	Spacing	Quantity
	Trees					
Cua	Cupaniopsis anacardioides	Tuckeroo	7 x 5	75L	As Shown	2
Er	Elaeocarpus reticulatus	Blueberry Ash	12 x 5	75L	As Shown	1
MTB	Magnolia grandiflora 'Teddy Bear'	Teddy Bear Magnolia	4 x 2.5	75L	As Shown	2
TL	Tristaniopsis 'Luscious'	Water Gum	10 x 8	75L	As Shown	2
MI	Melaleuca linariifolia	Snow in Summer	8 x 2.5	75L	As Shown	1
	Shrubs / Accents					
AsM	Acmena smithii 'Minor'	Dwarf Lilly Pilly	3 x 2	300mm	As Shown	72
Ca	Correa alba	White Correa	1 x 1.5	300mm	As Shown	116
CLJ	Callistemon 'Little John'	Bottlebrush	1.5 x 1.5	300mm	As Shown	22
De	Doryanthes excelsa	Gymea Lily	2 x 2	300mm	As Shown	31
MCT	Melaleuca linariifolia 'Claret Tops'	Honey Myrtle	1 x 1	300mm	As Shown	8
PRR	Photinia `Red Robin`	Photinia	2.5 x 3	300mm	As Shown	28
Wf	Westringia fruticosa 'Aussie Box'	Coastal Rosemary	$0.7 \times 0.7$	300mm	As Shown	32
	Groundcovers/ Grasses					
Dc	Dianella caerulea	Paroo Lily	$0.7 \times 0.7$	150mm	5/m2	18
Dr	Dichondra repens	Kindney Weed	$0.2 \times 1.5$	150mm	5/m2	12
Hv	Hardenbergia violacea	Purple Coral Pea	Spreading	150mm	5/m2	24
Hs	Hibbertia scandens	Golden Guinea Flower	0.2 x 1.5	150mm	5/m2	15
LT	Lomandra longifolia 'Tanika'	Mat Rush	$0.7 \times 0.7$	150mm	5/m2	25
Мp	Myporum parvifolium	Boobialla	0.2 x Spreading	150mm	5/m2	40
LJR	Liriope muscari 'Just Right'	Just Right Lily Turf	0.5 x 0.5	150mm	5/m2	44
PN	Pennisetum alopecuroides 'Nafray'	Fountain Grass	1.0 x 1.0	150mm	5/m2	22



Site Plan | Scale 1:150

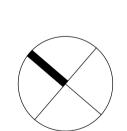

LAHC

LAHC 189 Riverside Drive, Airds, NSW 2560

Level 1, 3-5 Baptist Street Redfern NSW 2016

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SITE IMAGE

**Development Application** 

Landscape Coversheet

Scale N/A Job Number



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Site Boundary

Refer Arborist Report

Refer Arborist Report

Tree to be Removed

Refer Plant Schedule and Detail

Proposed Grasses and

Refer Plant Schedule and Detail

Refer Architectural Plans and Specifications

Groundcovers

Proposed Turf

**Proposed Paving** 

Concrete Edge

Picnic Table

**Existing Vegetation** 

JD NM 03.04.2023

JD NM 23.02.2023 NM 22.11.2022

LW NM 10.10.2022

LW NM 04.10.2022

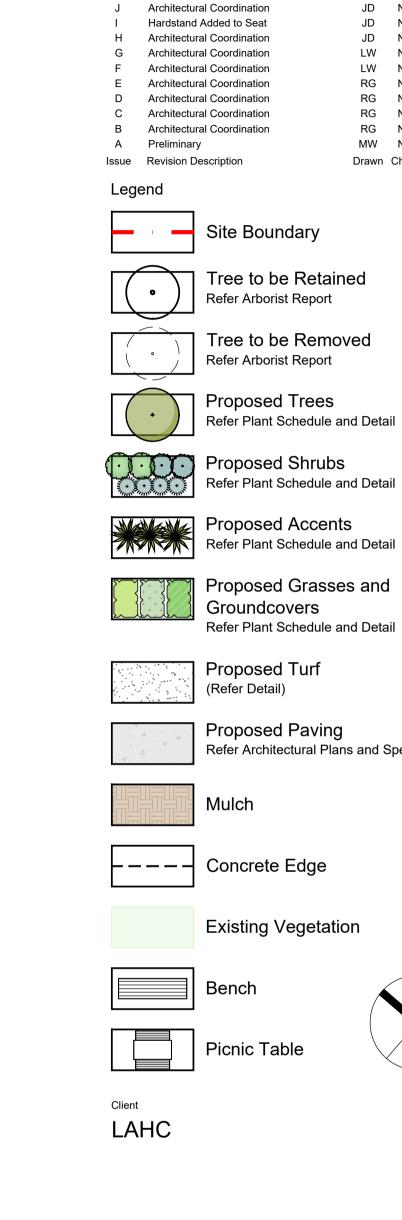
RG NM 14.07.2022

RG NM 07.07.2022 RG NM 17.05.2022

RG NM 16.05.2022

MW NM 14.04.2022

Drawn Check Date



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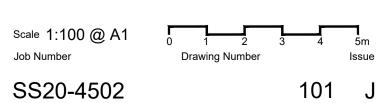


SITE IMAGE

**Development Application** 

Job Number

Landscape Plan







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Architectural Coordination Preliminary

MW NM 14.04.2022 Drawn Check Date

Turf as specified Nom 150 x 150mm concrete edge as specified Garden bed refer planting details Base course to specification Turf side Garden bed side

Typical Concrete Edge

Issue Revision Description

Turf as specified Soil mix type B and fertiliser as specified Rip subgrade to 100mm

Detail Turf on Even Grade 501 1:10

06 Typ 501 1:10

Refer to plans for adjacent surfaces and edging In-situ reinforced concrete paving slab. Waterproof membrane Compacted base course Compacted sub-grade to an even surface that allows the finished paving to meet design

03 Stepping Paver in Turf on Grade
501 1:10

Turf as specified

Soil mix type B

specification.

Refer specification

20mm mortar bed

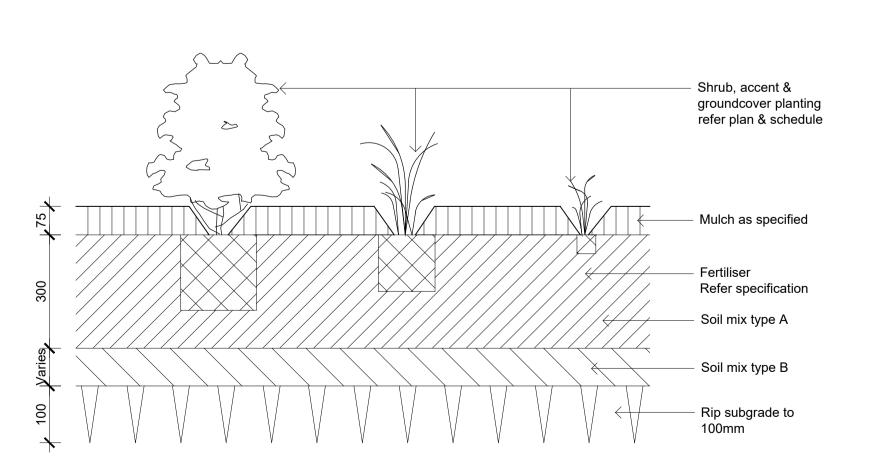
Compacted sub-grade

to Engineer's specification

Basecourse to engineers

Stepping paver as specified

Insitu Concrete Paving - On grade 501 1:10



Tree planting as plan & schedule

Hession ties above

Hardwood timber

specification for no.

Mulch as specified

Fertiliser as specified

Topsoil mix type A

Topsoil mix type B

Rip subgrade

Detail 75-200L Tree Planting on Grade

Refer specification.

Note: Install root barrier as required.

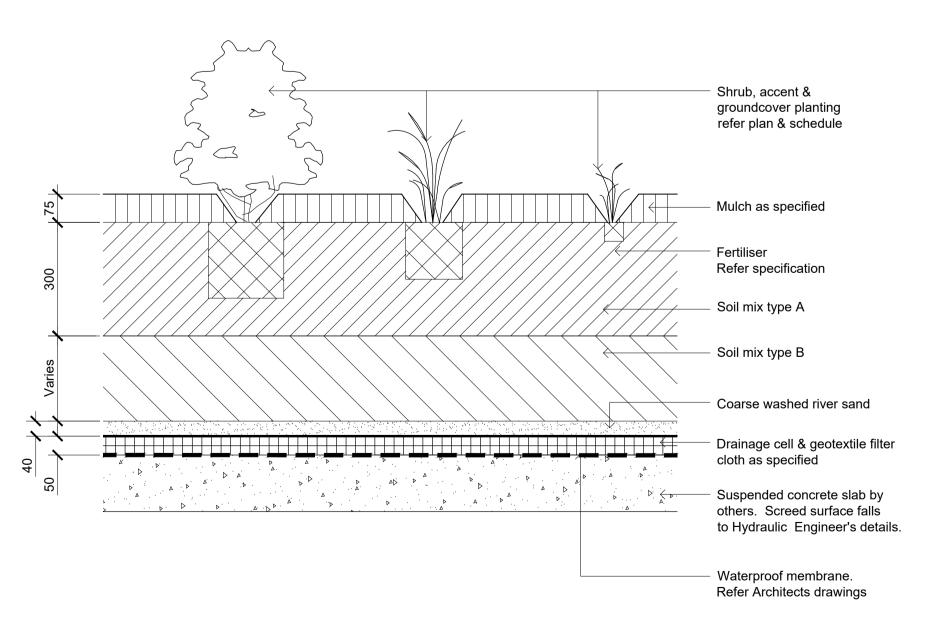
& size drive securely into ground and

stakes. refer to

avoid root ball

lowest limb to prevent slipping

02 Detail Shrub Accent & Groundcover Planting on Grade
501 1:10



Detail Shrub Accent & Groundcover Planting on Structure 501 1:10

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**Development Application** 

Landscape Details

Scale As Shown

Job Number

SS20-4502

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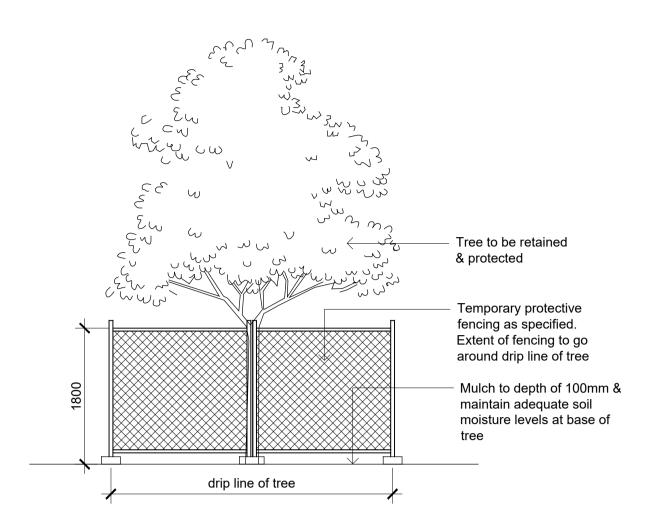
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RG NM 14.07.2022


Drawn Check Date


A Architectural Coordination

Issue Revision Description



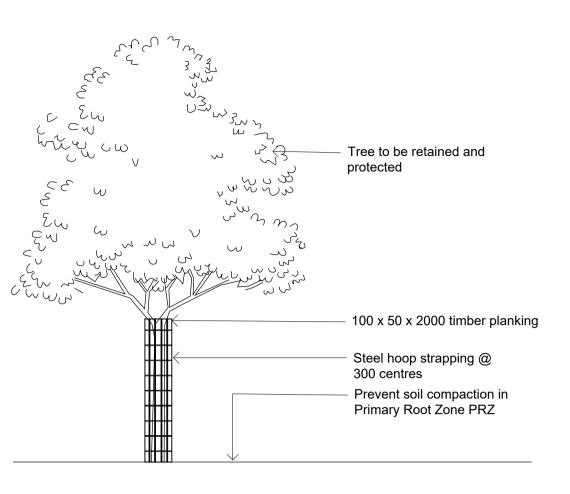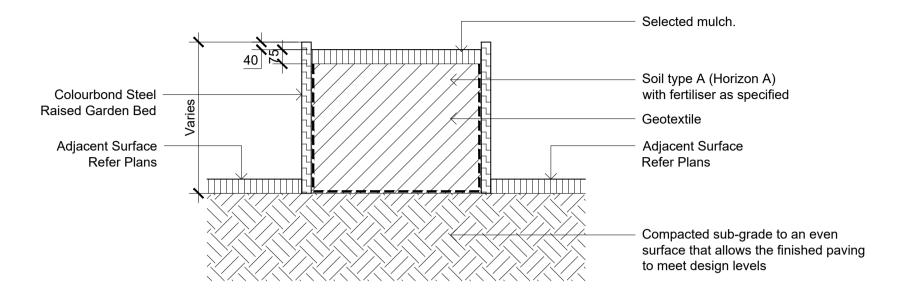Detail - Tree Protection Fencing





Section - Raised Planter Box

02 Detail - Tree Protection Planks
502 1:50

LAHC

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**Development Application** 

Landscape Details

Scale As Shown

Job Number

502 A

SS20-4502

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STORMWATER NOTES

SLOW RELEASE PIPE TO

STORMWATER SYSTEM

DETERMINED by the NSW Land and Housing Corporation on:

#### 10 October 2023

- S1. ALL STORMWATER DRAINAGE TO BE IN ACCORDANCE WITH AS 3500.3 AND COUNCIL REQUIREMENTS.
- DOWNPIPE LOCATIONS ARE INDICATIVE ONLY. FINAL LOCATIONS TO BE REFER TO ARCHITECT
- S3. ALL HABITABLE FLOOR LEVELS ARE TO BE AT LEAST 200 mm ABOVE FINISHED GROUND LEVELS ADJACENT TO NEW DWELLINGS.
- S4. WHERE PIPE SIZE NOT SHOWN ON DRAWING, USE 1000 UPVC (MIN. 1.0%)
- PRIOR TO ANY CONSTRUCTION ON SITE THE BUILDER SHALL CHECK THE ASSUMED LEVELS OF ALL UPSTREAM AND DOWNSTREAM EXISTING DRAINAGE STRUCTURES TO ENSURE THE VIABILITY OF THE PROPOSED WORKS. THE ENGINEER IS TO BE NOTIFIED IMMEDIATELY OF ANY DISCREPANCIES IN LEVELS OR LOCATION OF STRUCTURES.
- PRIOR TO ANY CONSTRUCTION ON SITE THE BUILDER SHALL CHECK THE LOCATION AND DEPTH OF ALL SEWER STRUCTURES TO ENSURE NO CONFLICT WITH THE PROPOSED WORKS.
- S7. A CHILD PROOF AND CORROSION RESISTANT FASTENING SYSTEM FOR THE ACCESS GRATES TO DETENTION TANK/TANKS/SILT ARRESTOR PIT /PIT GREATER THAN 600mm DEEP SHALL BE INSTALLED. (E.G. SPRING LOADED JAY-BOLT).
- S8. A 500mm x 200mm SIGN SHALL BE PLACED ADJACENT TO THE DETENTION TANK/SILT ARRESTOR PIT STATING THAT: "THIS DETENTION TANK/SILT ARRESTOR PIT SHALL BE REGULARLY INSPECTED AND CLEANED."
- S9. PIPES TO BE THRUST BORED TO MINIMISE ROOT DAMAGE IN THE VICINITY OF TREES.

ONLY ROOF RAINWATER ALLOWED TO DRAIN INTO RAINWATER TANK

ANY DOWNPIPE COLLECTING BALCONY STORMWATER TO BE CONNECTED TO STORMWATER PIT.

FIRST FLUSH DEVICES TO BE PROVIDED BEFORE DOWNPIPE CONNECTED TO RAINWATER TANK.

1, ALL STORMWATER PITS IN LANDSCAPE OR TURFED AREAS TO HAVE PERFORATED GALV. MESH BELOW GRATE

, ALL PITS/GRATE DRAIN IN TRAFFICABLE AREAS TO HAVE A GALVANISED HINGED BOLT DOWN AND HEELGUARD GRATES

PRIOR TO ANY CONSTRUCTION ON SITE THE BUILDER SHALL CHECK INVERT LEVEL OF EXISTING K.I.P. TO ENSURE NO CONFLICT WITH THE PROPOSED WORKS.

PRIOR TO ANY CONSTRUCTION ON SITE THE BUILDER SHALL CHECK THE LOCATION AND DEPTH OF ALL UNDERGROUND SERVICES TO ENSURE NO CONFLICT WITH THE PROPOSED WORKS.

THE CONTRACTOR SHALL ARRANGE AND PAY ALL FEES TO CONNECT TO COUNCIL'S STORMWATER SYSTEM, IN COMPLIANCE WITH COUNCIL REQUIREMENTS.

EXISTING PIT TO BE RESTORED AS PER EXISTING CONDITION, OTHERWISE THE APPLICANT NEEDS TO RECONSTRUCT THE PIT AS PER COUNCIL'S SATISFACTION.

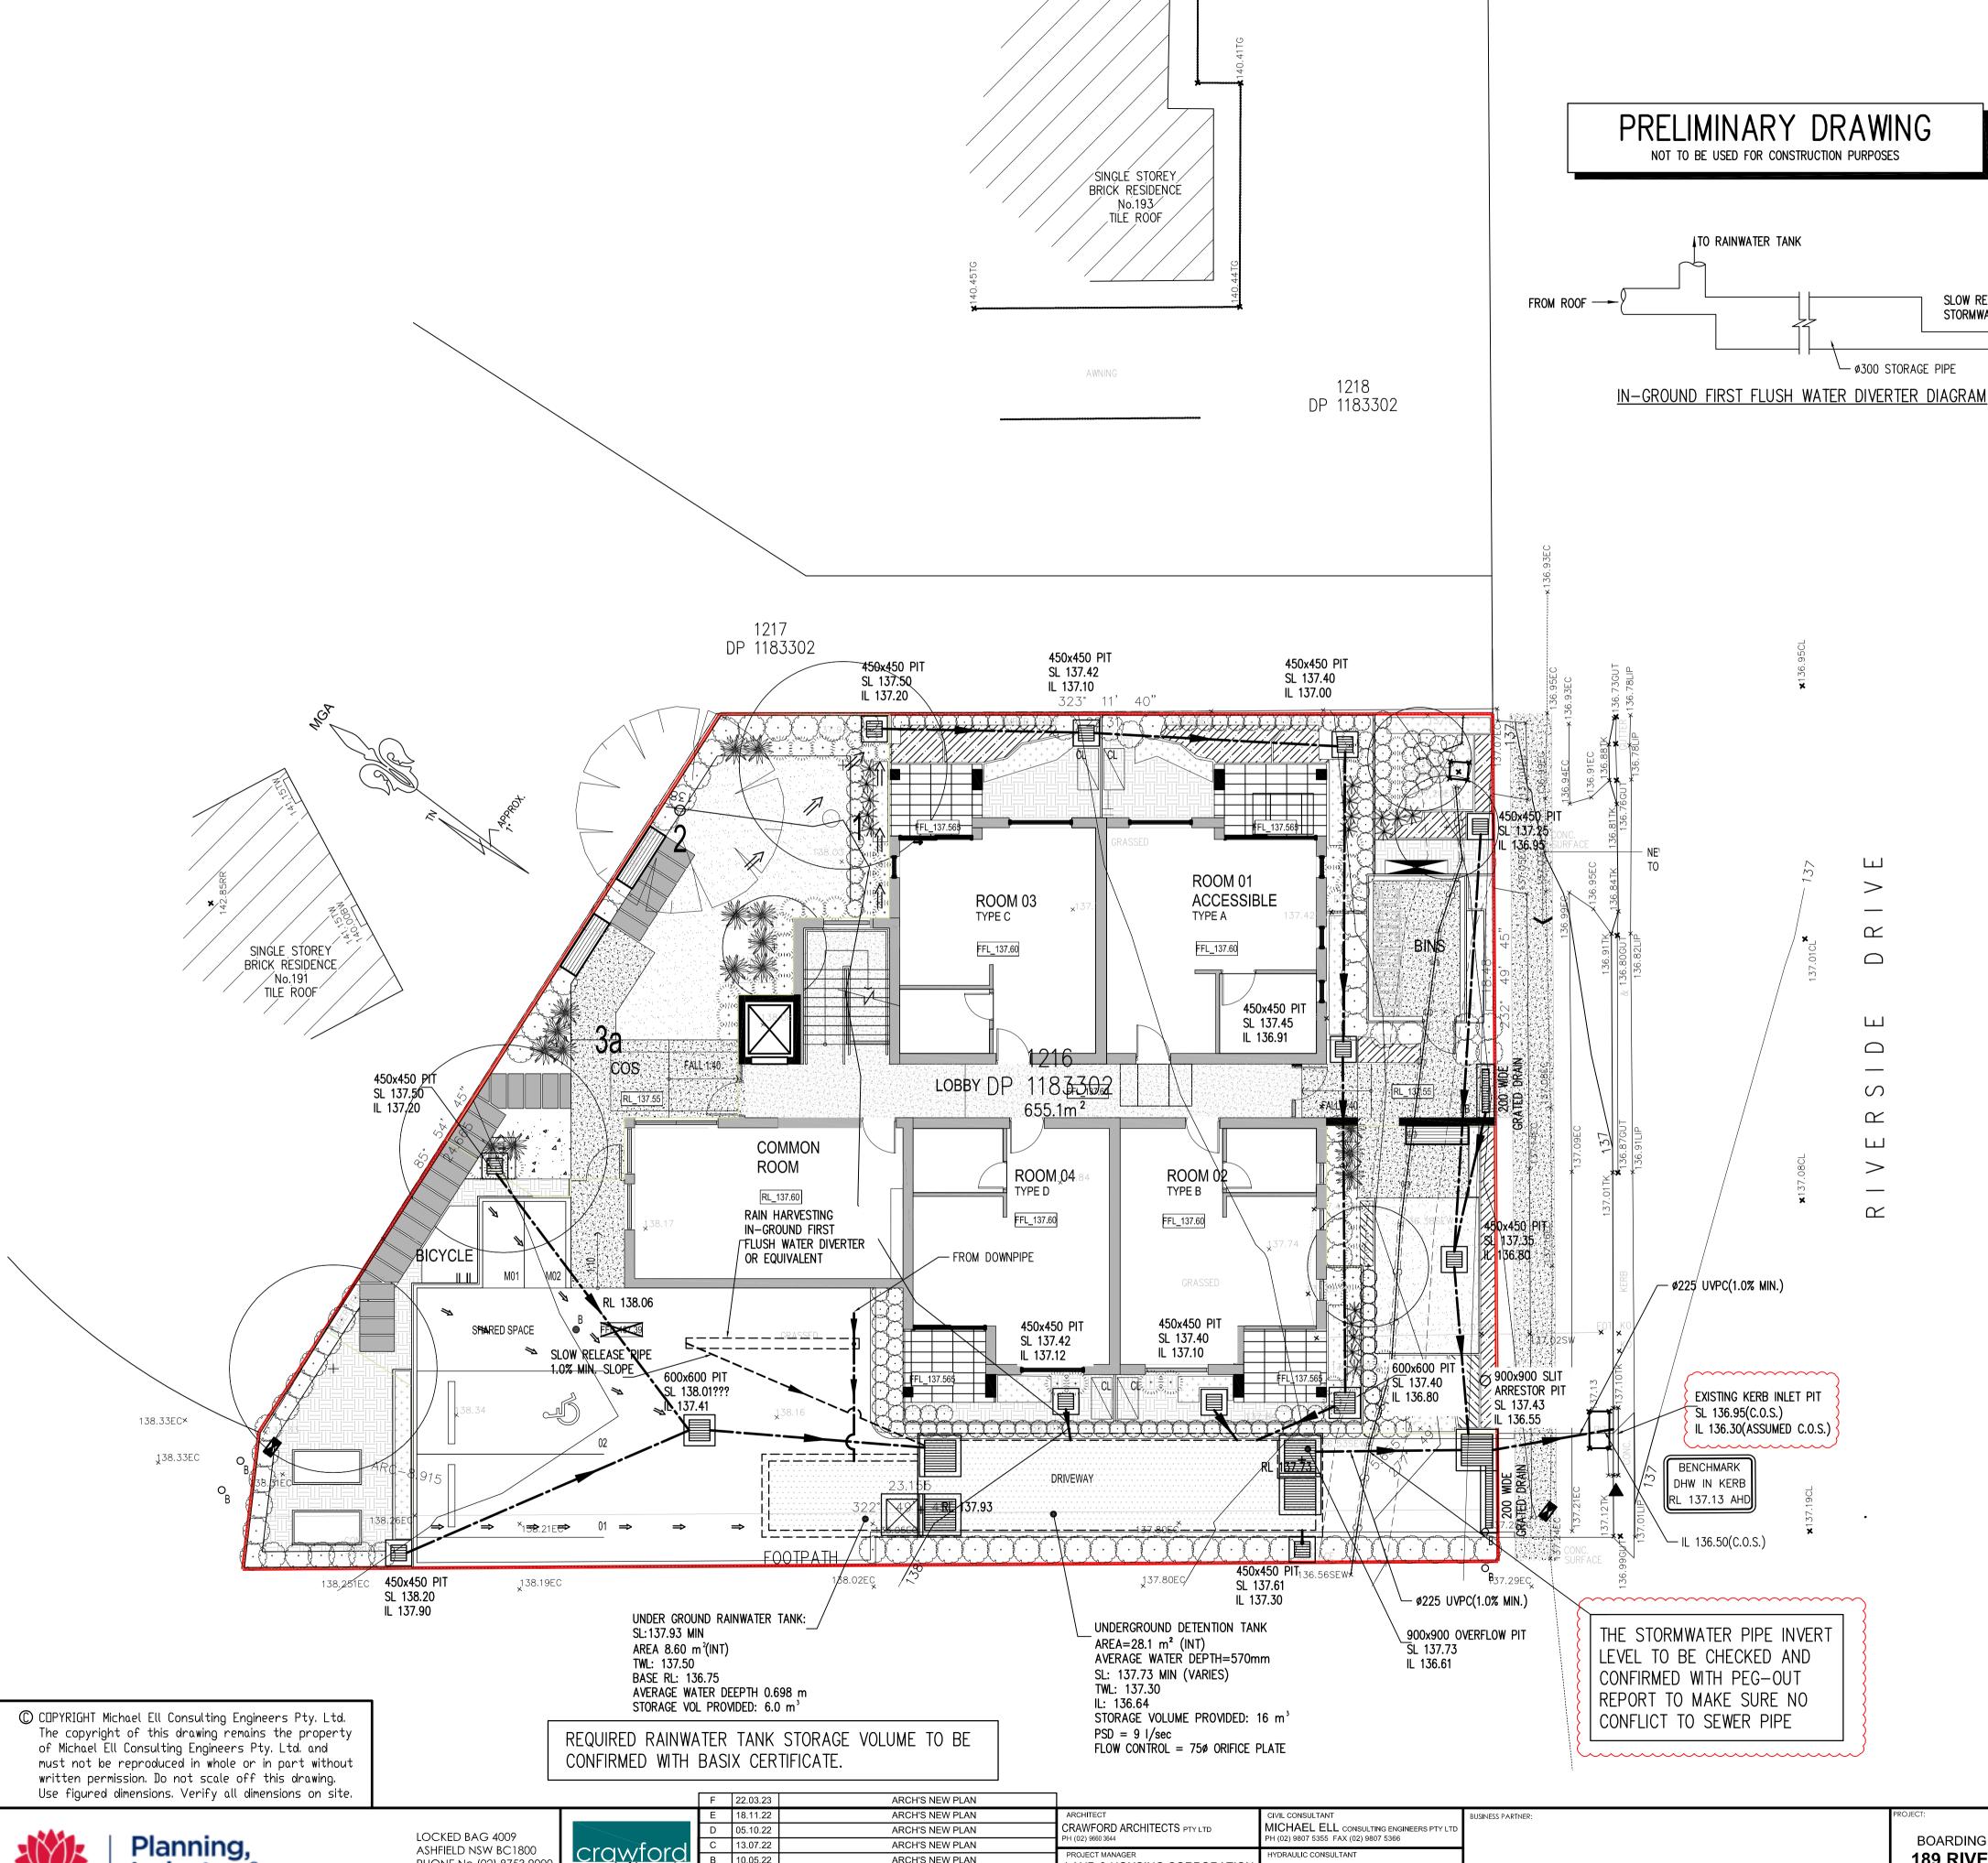
### STORMWATER SITE DRAINAGE LAYOUT PLAN

 ALL PIPELINES UNDER THE BUILDING SHALL BE CONSTRUCTED AND TESTED AS PER SECTION 10 OF AS/NZS 3500.3:2015 ALL PIPES SHALL BE SEWER GRADE EXTRA HEAVY DUTY. DENOTES \$150 UPVC WITH 1.0% MIN. SLOPE UNO..

DENOTES Ø100 UPVC WITH 1.0% MIN. SLOPE UNO.. OVERLAND FLOW DIRECTION.

FIRST FLUSH DEVICES TO BE PRIVED TO AUTHORITY'S REQUIREMENTS.

DENOTES TO BE CHECKED & CONFIRMED ON SITE.





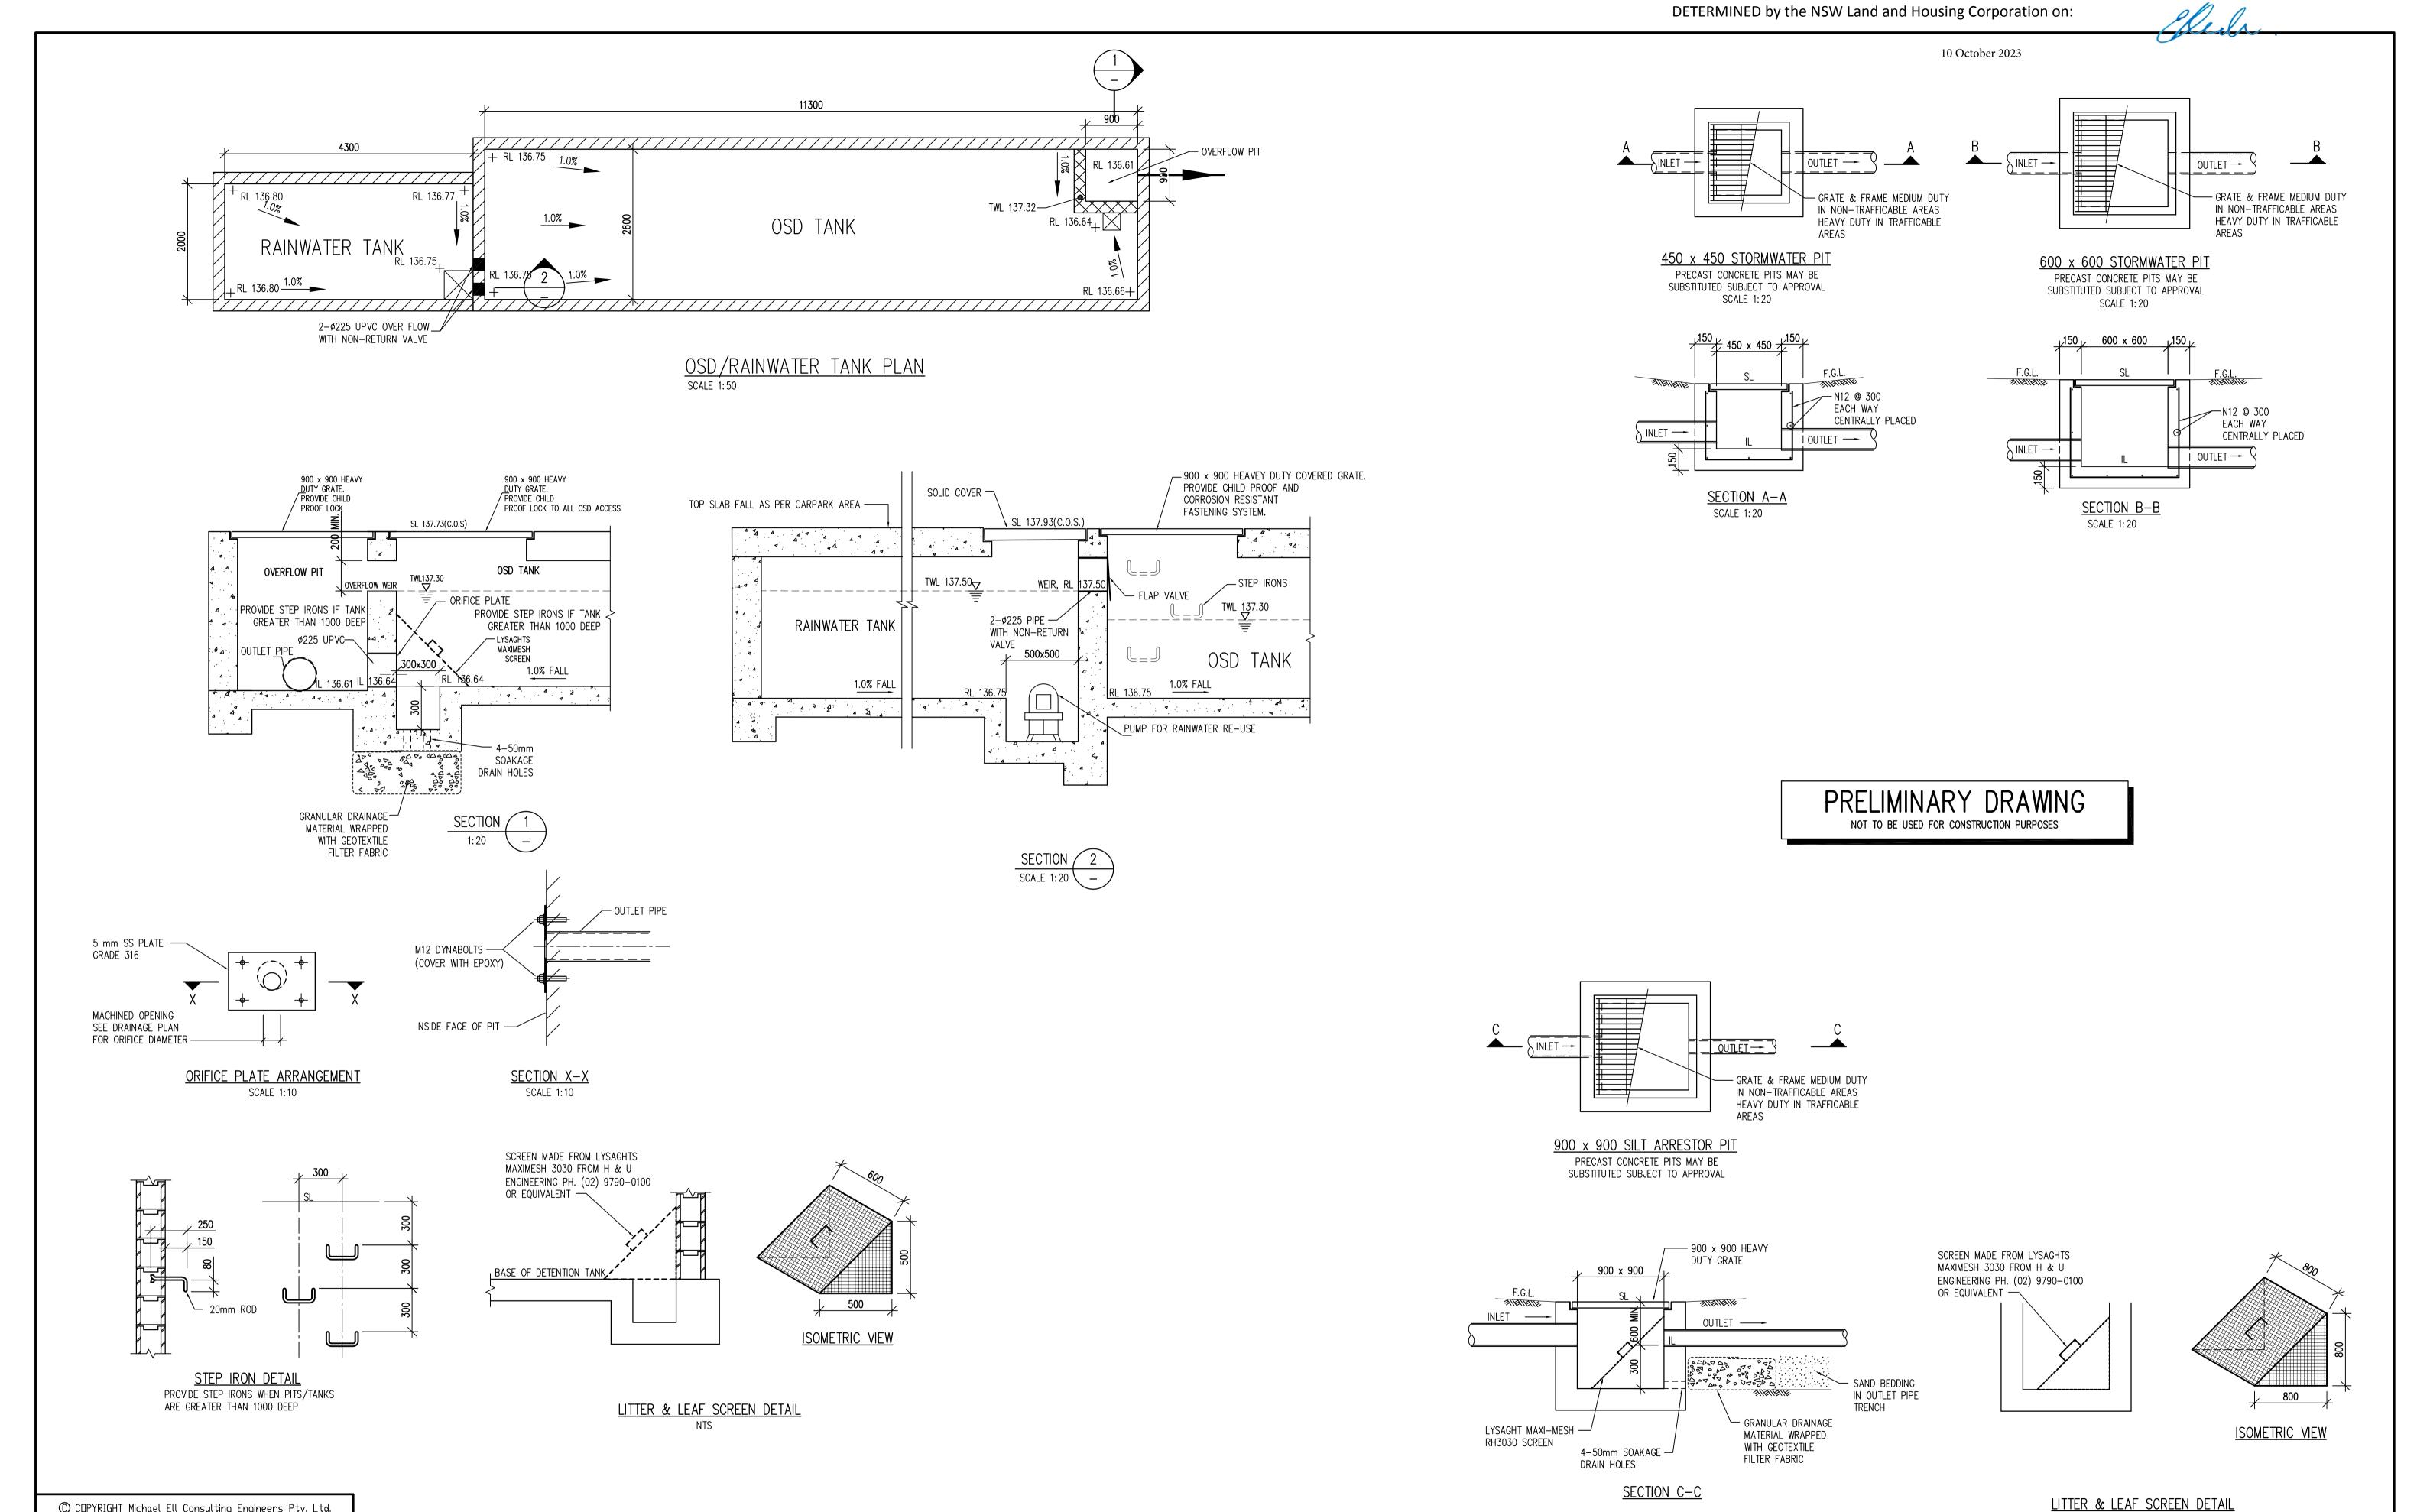
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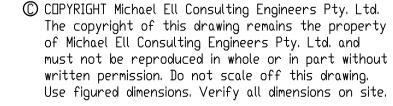
crawford architects 3 10.05.22 06.04.22 DATE

ARCH'S NEW PLAN LAND & HOUSING CORPORATION ARCH'S NEW PLAN PH (02) 8753 8100 FAX (02) 8753 8011 NOTATION/AMENDMENT ELECTRICAL CONSULTANT NDSCAPE CONSULTANT DO NOT SCALE DRAWINGS. CHECK ALL DIMENSIONS ON SITE. FIGURED DIMENSIONS TAKE PRECEDENCE.

**BOARDING HOUSING DEVELOPMENT** 189 RIVERSIDE DRIVE, **AIRDS, NSW, 2560** 

DA STORMWATER SITE DRAINAGE LAYOUT PLAN 07.02.22 BGWW7 1:100 22003 DC C01 22003-C01f





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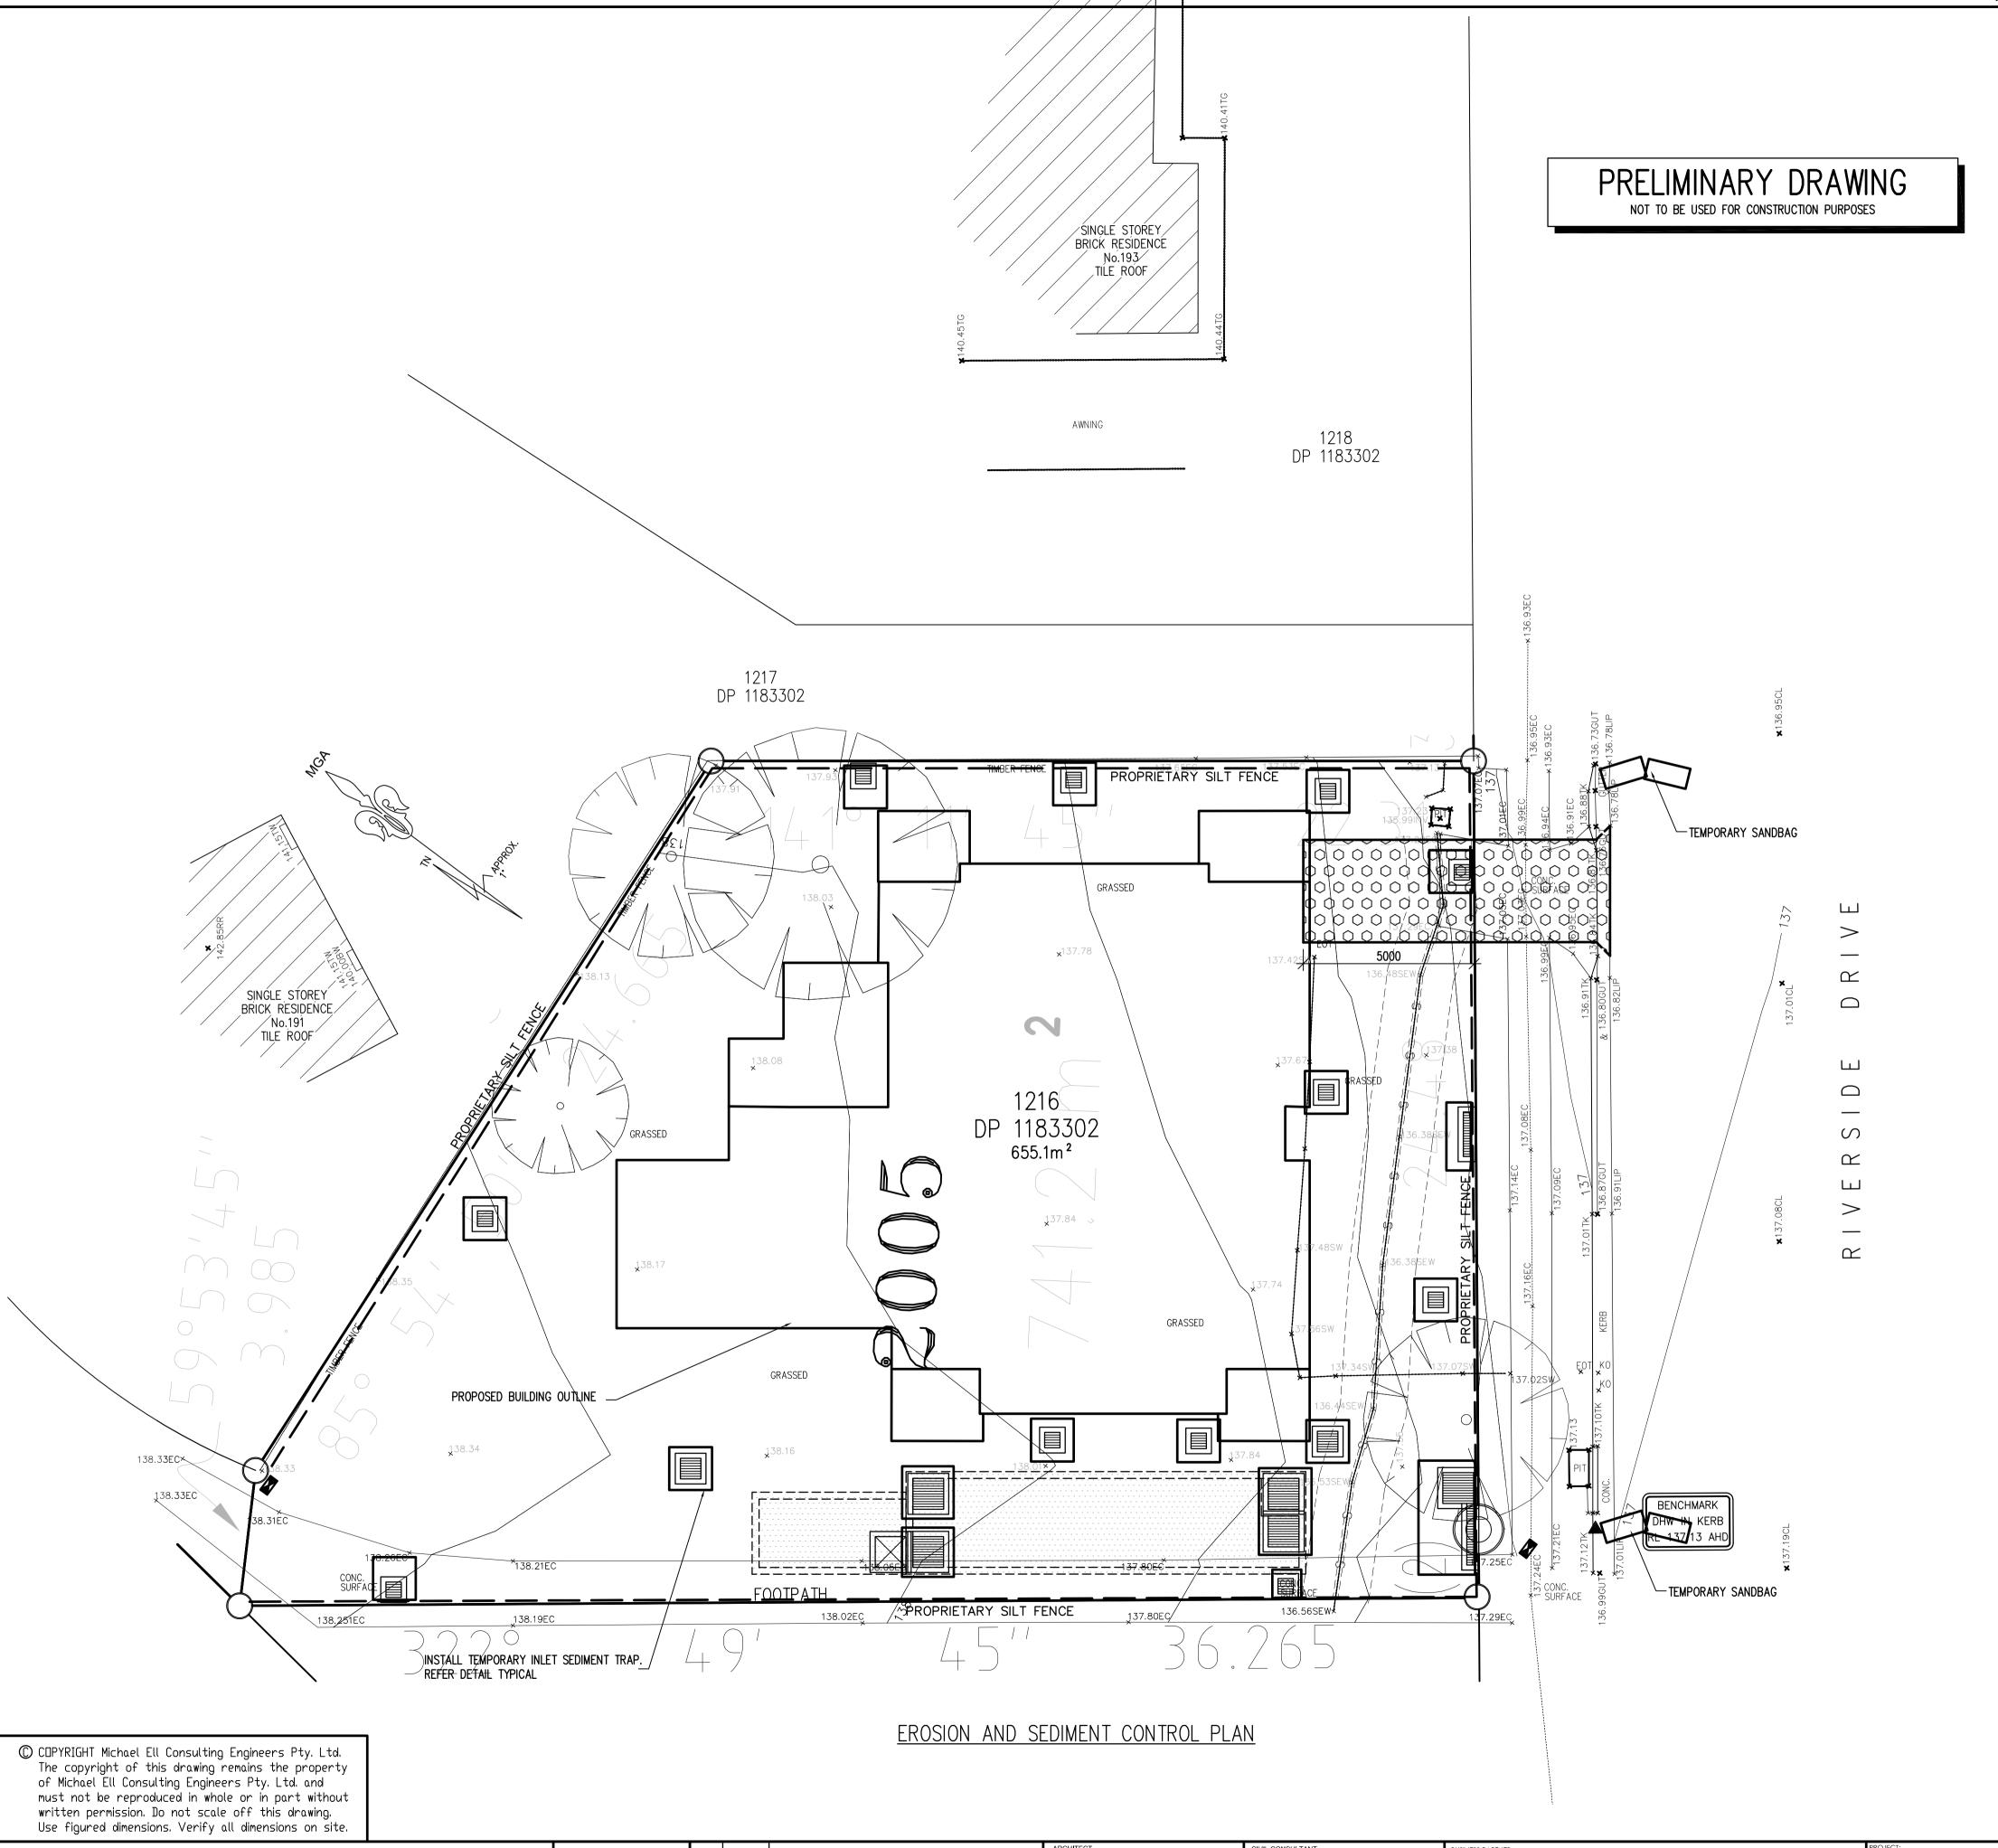
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				ARCHITECT CRAWFORD ARCHITECTS PTY LTD PH (02) 9660 3644	CIVIL CONSULTANT  MICHAEL ELL CONSULTING ENGINEERS PTY LT  PH (02) 9807 5355 FAX (02) 9807 5366
crawford	В	10.05.22	ARCH'S NEW PLAN	PROJECT MANAGER  LAND & HOUSING CORPORATION	HYDRAULIC CONSULTANT
architects	Α	06.04.22	ARCH'S NEW PLAN	PH (02) 8753 8100 FAX (02) 8753 8011	
	REV	DATE	NOTATION/AMENDMENT	ELECTRICAL CONSULTANT	LANDSCAPE CONSULTANT
		DO NOT	SCALE DRAWINGS. CHECK ALL DIMENSIONS ON SITE. FIGURED DIMENSIONS TAKE PRECEDENCE.		

BOARDING HOUSING DEVELOPMENT
189 RIVERSIDE DRIVE,
AIRDS, NSW, 2560

STORMWATER DE	TAILS	STATUS:	ı	DA	
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		07.02.22	1:20	22003	BGWW7
		STAGE:	DRAWN:	CHECKED:	APPROVED:
		DA	DC	ME	ME
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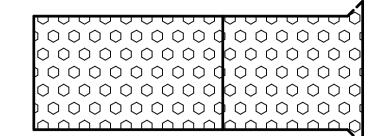


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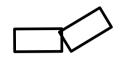
10 October 2023

PROPOSED BUILDING OUTLINE

PROPRIETARY SILT FENCE



TEMPORARY CONSTRUCTION EXIT



TEMPORARY HAY BALES/SANDBAGS



PROPOSED DRAINAGE PIT WITH INLET SEDIMENT TRAP

#### **EROSION CONTROL NOTES:**

- ALL EROSION AND SEDIMENT CONTROL MEASURES TO BE INSTALLED PRIOR TO SITE DISTURBANCE
- 2. STRIPPING OF GRASS AND VEGETATION ETC. FROM SITE SHALL BE KEPT TO A MINIMUM
- 3. TOPSOIL FROM ALL AREAS THAT WILL BE DISTURBED TO BE STRIPPED AND STOCKPILED ON SITE.
- 4. ALL SEDIMENT CONTROL STRUCTURES TO BE INSPECTED AFTER EACH RAINFALL EVENT FOR STRUCTURAL DAMAGE AND ALL TRAPPED SEDIMENT TO BE REMOVED TO A NOMINATED SOIL STOCKPILE SITE



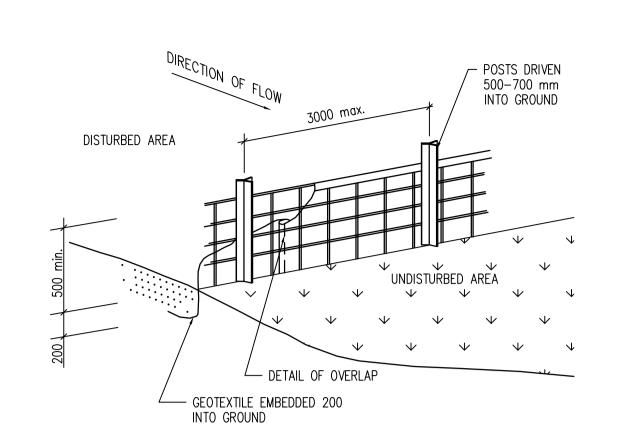
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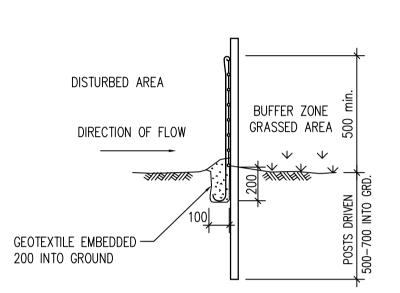
				ARCHITECT	CIVIL CONSULTANT
	D	11.01.23	ARCH'S NEW PLAN		MICHAEL ELL CONSULTING ENGINEERS PTY L
arayyford	С	05.10.22	ARCH'S NEW PLAN	, ,	PH (02) 9807 5355 FAX (02) 9807 5366
crawford	В	10.05.22	ARCH'S NEW PLAN	PROJECT MANAGER LAND & HOUSING CORPORATION	HYDRAULIC CONSULTANT
architects	Α	06.04.22	ARCH'S NEW PLAN	PH (02) 8753 8100 FAX (02) 8753 8011	
	REV	DATE	NOTATION/AMENDMENT	ELECTRICAL CONSULTANT	LANDSCAPE CONSULTANT
		DO NOT	SCALE DRAWINGS. CHECK ALL DIMENSIONS ON SITE. FIGURED DIMENSIONS TAKE PRECEDENCE.		2.00001.

**BOARDING HOUSING DEVELOPMENT** 189 RIVERSIDE DRIVE, **AIRDS, NSW, 2560** 

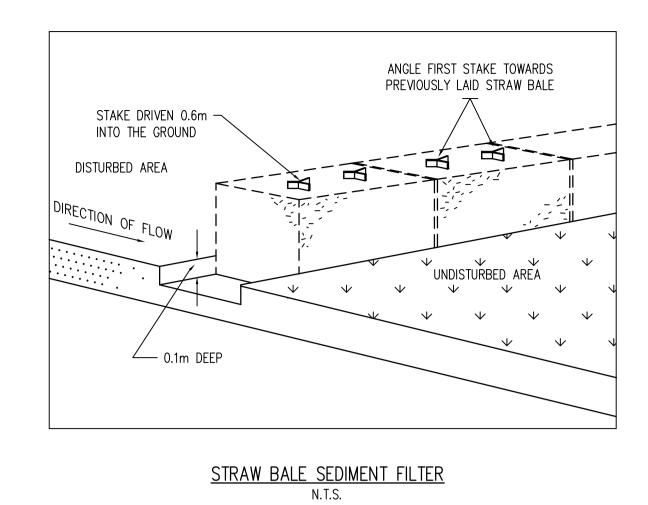
FROSION AND SEC	ROSION AND SEDIMENT		[	DΑ	
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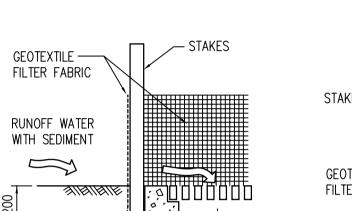







GEOFABRIC LINED 'SILT' FENCE N.T.S.







FILTERED WATER

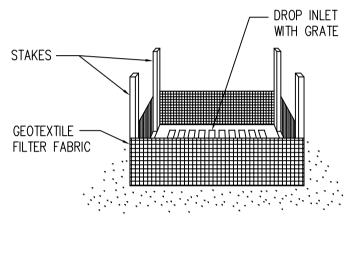
BURIED — FABRIC



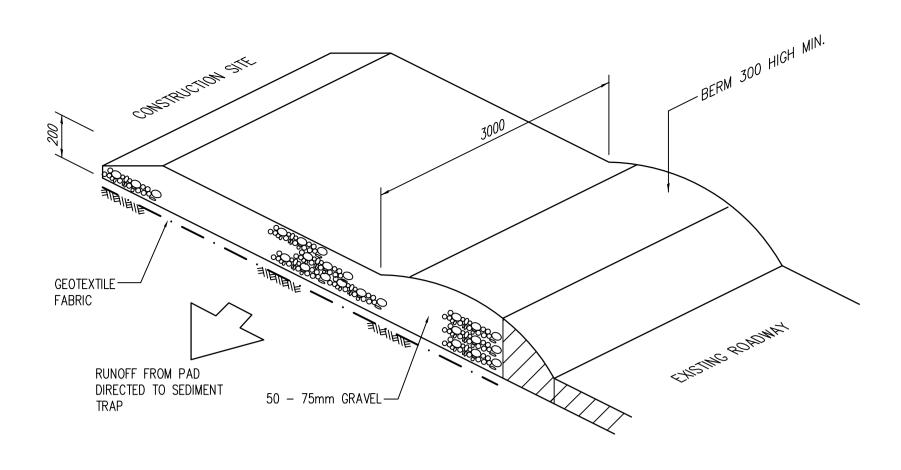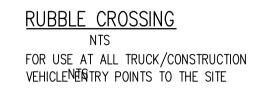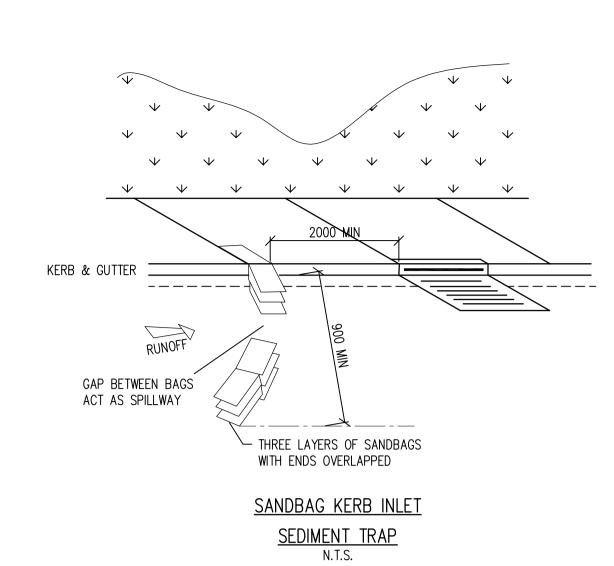GEOTEXTILE FILTER FABRIC DROP INLET SEDIMENT TRAP







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			ARCHITECT  CRAWFORD ARCHITECTS PTY LTD PH (02) 9660 3644	CIVIL CONSULTANT  MICHAEL ELL CONSULTING ENGINEERS PTY LTD PH (02) 9807 5355 FAX (02) 9807 5366	BUSI
			PROJECT MANAGER  LAND & HOUSING CORPORATION PH (02) 8753 8100 FAX (02) 8753 8011	HYDRAULIC CONSULTANT	
REV	DATE	NOTATION/AMENDMENT	ELECTRICAL CONSULTANT	LANDSCAPE CONSULTANT	1
	DO NOT	SCALE DRAWINGS. CHECK ALL DIMENSIONS ON SITE. FIGURED DIMENSIONS TAKE PRECEDENCE.		BANDOOAN E GONGGEITANA	

TROJECT.
BOARDING HOUSING DEVELOPMEN
189 RIVERSIDE DRIVE,
AIRDS, NSW, 2560

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## NOTIFICATION PLANS BOARDING HOUSE DEVELOPMENT

189 RIVERSIDE DR, AIRDS, NSW 2560 LOT: 1216 / DP: 1183302 / DP: 609357







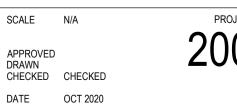








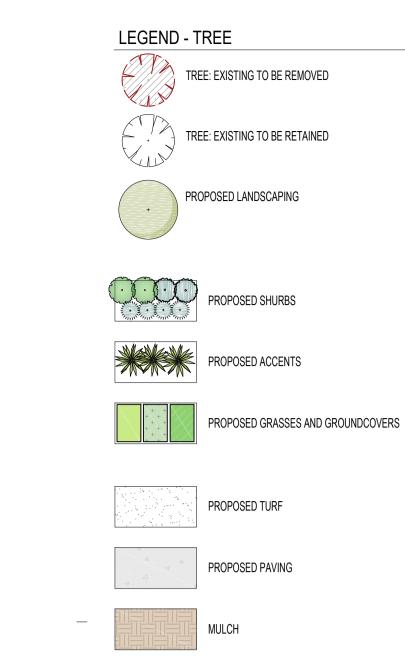












COMMUNAL OPEN SPACE

PATHWAY

PLANT SCHEDULE

Symbol	Botanic Name	Common Name	Height x Width (m)	Pot Size	Spacir
	Trees				
Cua	Cupaniopsis anacardioides	Tuckeroo	7 x 5	75L	As Sho
Er	Elaeocarpus reticulatus	Blueberry Ash	12 x 5	75L	As Sho
MTB	Magnolia grandiflora 'Teddy Bear'	Teddy Bear Magnolia	4 x 2.5	75L	As Shov
TL	Tristaniopsis 'Luscious'	Water Gum	10 x 8	75L	As Sho
МІ	Melaleuca linariifolia	Snow in Summer	8 x 2.5	75L	As Sho
	Shrubs / Accents				
AsM	Acmena smithii 'Minor'	Dwarf Lilly Pilly	3 x 2	300mm	As Sho
Ca	Correa alba	White Correa	1 x 1.5	300mm	As Sho
CLJ	Callistemon 'Little John'	Bottlebrush	1.5 x 1.5	300mm	As Sho
De	Doryanthes excelsa	Gymea Lily	2 x 2	300mm	As Sho
MCT	Melaleuca linariifolia 'Claret Tops'	Honey Myrtle	1 x 1	300mm	As Sho
PRR	Photinia `Red Robin`	Photinia	2.5 x 3	300mm	As Show
Wf	Westringia fruticosa 'Aussie Box'	Coastal Rosemary	0.7 x 0.7	300mm	As Sho
	Groundcovers/ Grasses				
Dc	Dianella caerulea	Paroo Lily	$0.7 \times 0.7$	150mm	5/m2
Dr	Dichondra repens	Kindney Weed	0.2 x 1.5	150mm	5/m2
Hv	Hardenbergia violacea	Purple Coral Pea	Spreading	150mm	5/m2
Hs	Hibbertia scandens	Golden Guinea Flower	0.2 x 1.5	150mm	5/m2
LT	Lomandra longifolia 'Tanika'	Mat Rush	$0.7 \times 0.7$	150mm	5/m2



84 DP 609357

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23.03.09 DA ISSUE 23.02.28 DA ISSUE

23.01.06 DA ISSUE

ISSUE DATE AMENDMENTS

NSW GOVERNMENT

**NSW LAHC** LOCKED BAG 5022 PARRAMATTA NSW 2124 PHONE: 1800 738 718

**BOARDING HOUSE** DEVELOPMENT LOT: 1216 / DP:1183302 189 RIVERSIDE DR, AIRDS, NSW 2560






# NOTIFICATION PLANS BOARDING HOUSE DEVELOPMENT

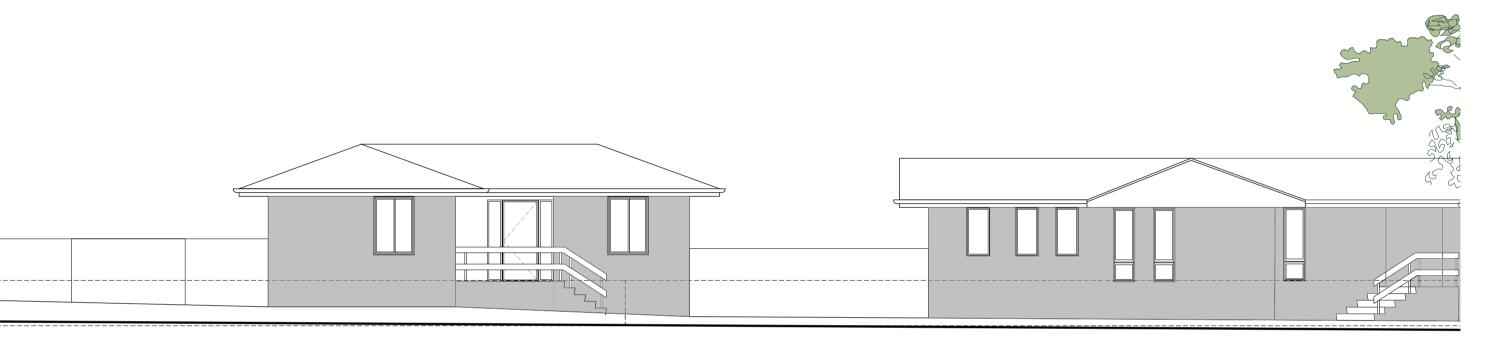
189 RIVERSIDE DR, AIRDS, NSW 2560 LOT: 1216 / DP: 1183302 / DP: 609357






	Р	ROPOSED	DEVELOPMENT DA	TA			
SITE AREA PROPOSED (sqm)							
TITLE DESCRIPTION		1216 (D.P.1183302) / Elizabeth Walk (D.P.609357)					
PROPOSED NUMBER OF DWELLINGS			8 rooms - 8 Studios (100%)				
			REQUIREMENT	PROPOSED			
SETBACKS		Front Setback	5.5m (Note: Min 4m required for MDH under DCP)	3.91m			
	Campbelltown Sustainable City DCP Vol.1 (Boarding houses s.17.2.3)	Side Setback	0.9m (ground) 1.5m (above ground level) (Note: Min 0.9m required for MDH under DCP)	1.5m			
		houses	Rear Setback	5m (ground) 10m (above ground level) (note: Min 4m/ground floor and 6m/upper floor required for MDH under DCP)	4m		
BUILDING HEIGHT	Housing	3 SEPP	9m	7.64m			
FSR	Campbe	lltown LEP	0.55:1	0.55			
PARKING	Housing SEPP	Accessible	8 x 0.2 = 1.6 car spaces	2 spaces			
MOTORCYCLE	Housin	g SEPP	8 / 5 = 2 motorcycle spaces (Min. 1 motorcycle space per 5 rooms)	2 spaces			
BICYCLE	Housin	g SEPP	(Bicycle: Apply the rates for an RFB under the Campbelltown DCP which is 1 space per 5	4 spaces			



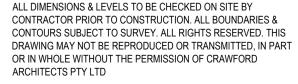

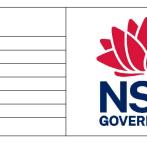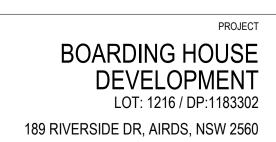
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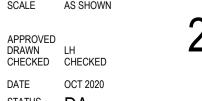








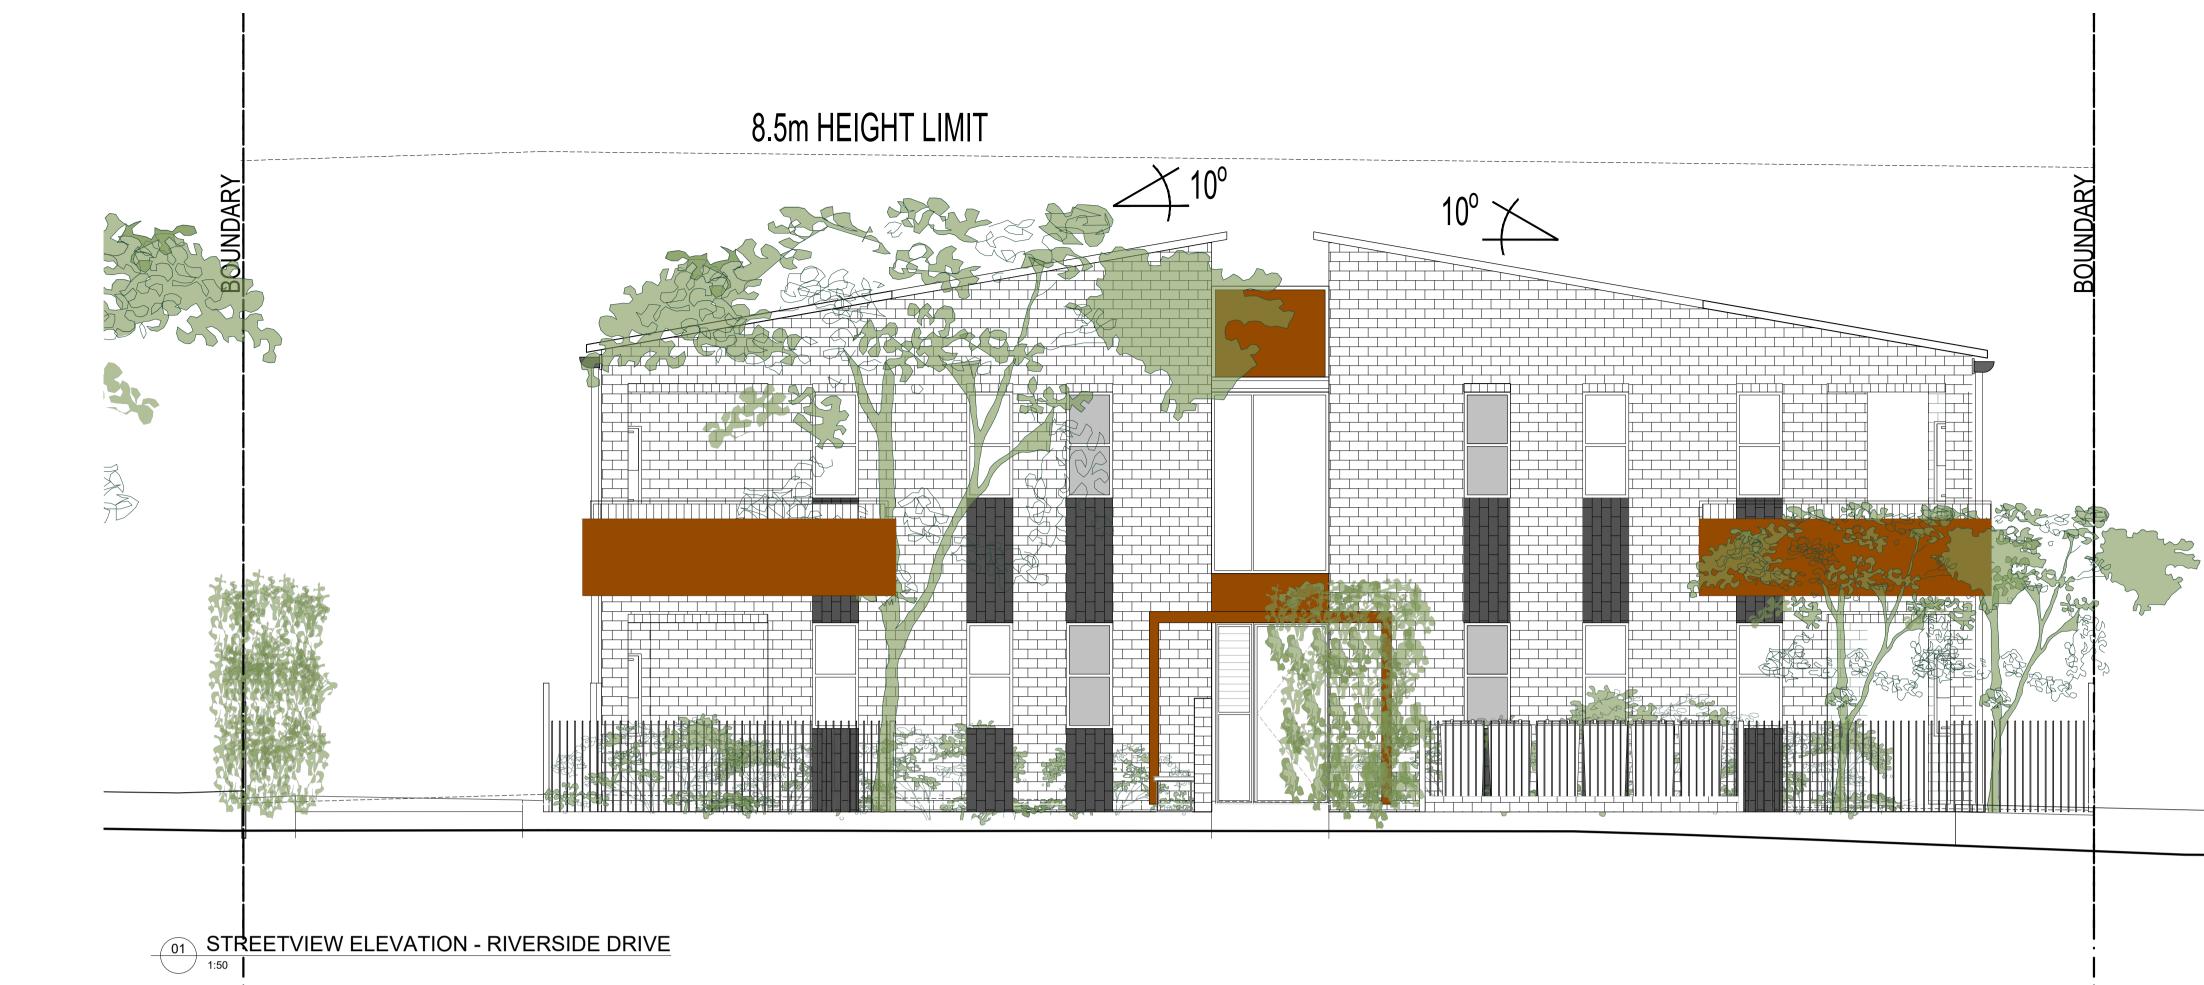













EXTERNAL FINISHES


ELEMENTS	MATERIALS	CODE	FINISHES / COLOUR / MANUFACTURER
ROOF	METAL CLADDING	MC-1	FIELDERS SHADOWLINE 305 OR SIMILAR COLORBOND COLOUR: DUNE MATT
FACIA, GUTTER / DOWNPIPE	METAL CLADDING	MC-2	FIELDERS OR SIMILAR  COLORBOND COLOUR: MONUMENT MATT
WALLS	BRICK	BF-1	AUSTRAL BRICKS - NUBRIK ARTISAN - AURORA OR SIMILAR
	BRICK	BF-2	AUSTRAL BRICKS - METALLIX - BLACKSTONE OR SIMILAR
	RENDER	CF-1	DULUX COLOUR: TERRAIN


WINDOW AND DOORS	ALUMINIUM FRAME WITH STANDARD LAMINATED GLASS TO BCA & BASIX	AF-1	COLORBOND COLOUR: MONUMENT MATT	
FENCING	STEEL FENCING	FF-1	COLORBOND FENCING COLOUR : DUNE	
WINDOW SHADES AND AWNING	ALUMINIUM AWNING	SF-1	HEKA HOODS CORE SERIES COLORBOND COLOUR: TERRAIN	
WINDOW SHADES AND AWNING	FIBRE CEMENT CLADDING	FC-1	POWDER COATED FINISH COLORBOND COLOUR: TERRAIN	



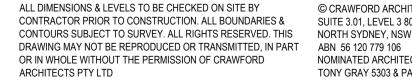

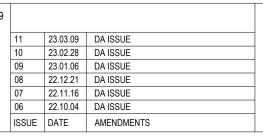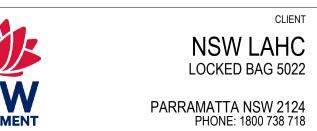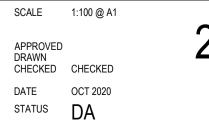
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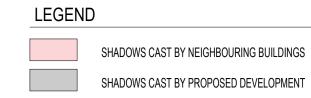
**BOARDING HOUSE** DEVELOPMENT LOT: 1216 / DP:1183302 189 RIVERSIDE DR, AIRDS, NSW 2560






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23.03.09 DA ISSUE 22.12.21 DA ISSUE 22.12.07 DA ISSUE 22.11.16 DA ISSUE 22.10.04 DA ISSUE 03 22.07.25 REVISED DA ISSUE 22.05.18 REVISED DA ISSUE 22.04.13 DA ISSUE


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LOT: 1216 / DP:1183302 189 RIVERSIDE DR, AIRDS, NSW 2560



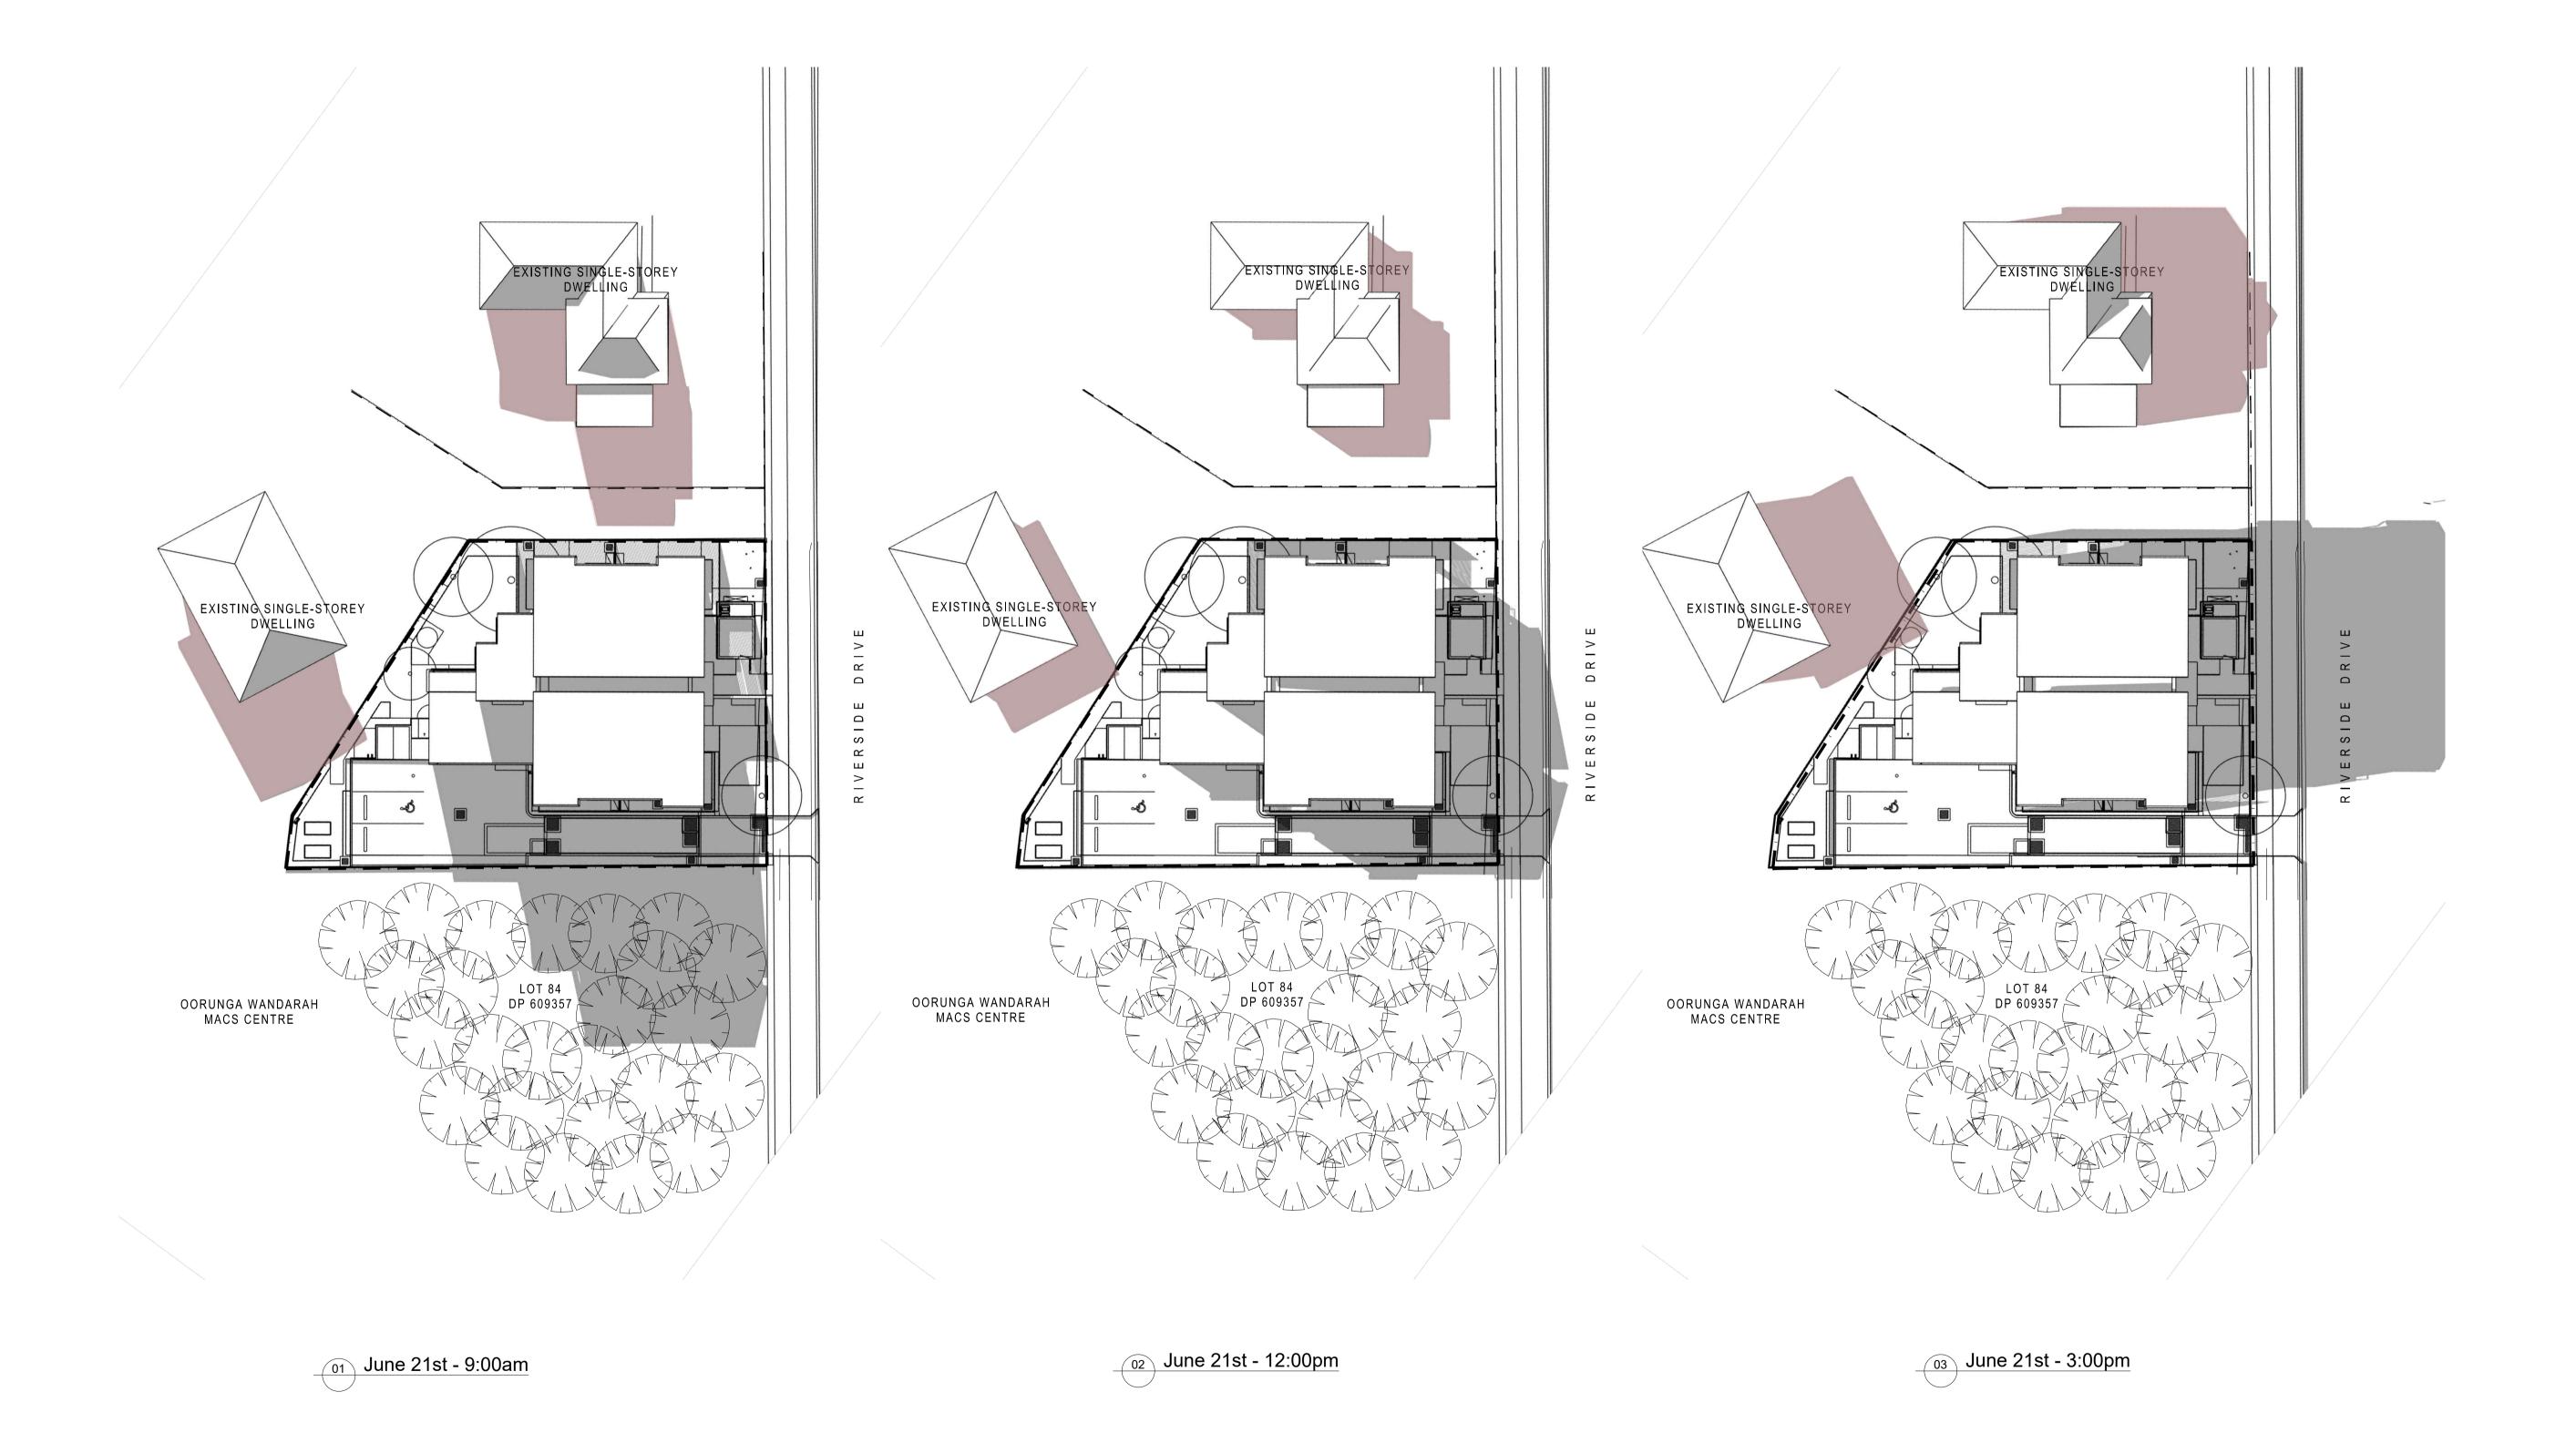
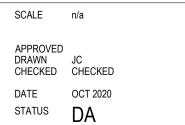
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